CONTROLLING NO.

CITY OF CARSON

PLANNING COMMISSION STAFF REPORT

PUBLIC HEARING: September 27, 2022

SUBJECT: Mitigated Negative Declaration/MMRP

General Plan Amendment (GPA) No. 109-20

Zone Change (ZCC) No. 184-21 Specific Plan (SP) No. 23-20

Site Plan Design Overlay Review (DOR) No. 1832-20

APPLICANT: Sagecrest Planning + Environmental

c/o David Blumenthal, AICP

2400 E. Katella Avenue, Suite 800

Anaheim, CA 92806

PROPERTY OWNER: Kim Family Trust

P.O. Box 24

Palos Verdes Estates, CA 90214

REQUEST: Consider approval of a proposed 19-unit multiple-

family residential development on two vacant parcels.

PROPERTY INVOLVED: 21240-21250 Main Street (APNs 7334-002-007 & 008)

COMMISSION ACTION

AYE	NO		AYE	NO	
		Chairperson (Vacant)			Hernandez
		Vice-Chair Palmer			Huff
		Diaz			Monteclaro
		Docdocil			Rashad
		Guerra			D. Thomas
					Alt. (Vacant) Alt. Mfume Alt. Wilson

Item No. 1

I. Introduction

Property Owner
Kim Family Trust
P.O. Box 24
Palos Verdes Estates, CA 90214

Applicant
Sagecrest Planning + Environmental
c/o David Blumenthal, AICP
2400 E. Katella Avenue, No. 800
Anaheim, CA 92806

II. Project Description

The proposed project is a 19-unit, multiple-family residential development consisting of two separate 3-story-high buildings on two vacant parcels totaling 0.52 acres. 21250 Main Street (Lot A) will be developed with a 12,331 square foot 11 unit building with 24 at grade parking spaces. 21240 Main Street (Lot B) will be developed with a 10,152 square foot 8 unit building with 18 at grade parking spaces.

For the proposed project to be approved in compliance with the City's Municipal Code, the applicant requests approval of the following entitlement requests:

- General Plan Amendment (GPA) No. 109-20 (changing General Plan Land Use Designation from General Commercial to Urban Residential)
- Zone Change (ZCC) No. 184-21 (changing zoning from Commercial General with a Design Overlay (CG-D) to Carson Lofts Specific Plan (CLSP)
- Specific Plan (SP) No. 23-20 (adopting Carson Lofts Specific Plan)
- Site Plan and Design Review (DOR) No. 1832-20

III. Project Site and Surrounding Land Uses

The subject property is in the CG-D (Commercial General – Design Review) Zone and is designated General Commercial under the Land Use Element of the General Plan. The subject project site is located on the northeast corner of 213th Street and Main Street at 21240-21250 Main Street. See Figure A, showing the Project Site and Regional Location.

Land uses surrounding the proposed project site are primarily residential uses to the south, west and east, and commercial to the north.



Figure (A) Project Site in context to surrounding area.

The following provides a summary of the site information:

Site Information				
General Plan Land Use Designation	General Commercial			
Zone District	Commercial General, Design Overlay (CG-D)			
Site Size	0.52 acres			
Present Use and Development	Vacant Land			
Surrounding Uses/ Zoning	North: Commercial General			
	South: Single-Family Residential; RS			
	East: Single-Family Residential; RS			
	West: Single-Family Residential; RS			
Access	Ingress/Egress: 213 th Street and Main Street			

IV. Analysis

Site History

City records indicate the following chronology of uses. All improvements were demolished in 1987 and the site has remained vacant since.

- 1947 Gas Station
- 1952 Real Estate Office
- 1956 Grocery Store
- 1960 Beer Bar
- 1965 Church

Site Plan

The subject property measures approximately 0.52-acres. The proposed residential development includes two separate 3-story-high buildings measuring 12,331 square feet (Lot A) with 24 at grade parking spaces and 10,152 square feet (Lot B) with 18 at grade parking spaces. Both will include recreational open space as required by the proposed specific plan.

The buildings will provide a five-foot setback from 213th Street, a five-foot setback from Main Street, a ten-foot setback from the eastern property line, and a ten-foot setback from the northern property line. There is a 23-foot separation between the two buildings. Each building has a maximum height of 39 feet. A six-foot tall decorative block wall is proposed along the eastern property line. In addition, a hedge of Laurus nobilis (Sweet Bay) will be provided along the eastern property line. The Sweet Bay can reach a mature height between 12' and-15' which will allow additional screening between the project and the adjoining residences to the east of the subject property.

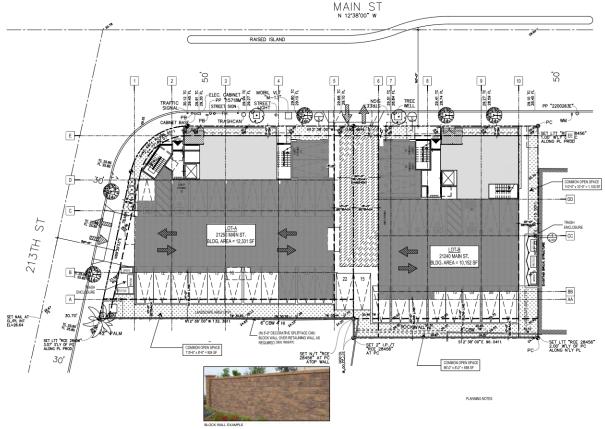


Figure (B) Site Plan

Access

The proposed development will have pedestrian and vehicular access from 213th Street and Main Street. Recordation of a reciprocal easement agreement is a condition of approval to ensure reciprocal access between the parcels in perpetuity.

Parking & Traffic

A traffic study conducted as part of the CEQA Initial Study/Mitigated Negative Declaration (IS/MND) estimates that the project will generate 103 daily trips, seven (7) AM peak hour trips and eight (8) PM peak hour trips. This did not rise to the level of significance for transportation impacts and thus did not result in any proposed mitigation measures.

The proposed Specific Plan will require 2 at grade covered parking spaces per unit, plus 1 guest space for every 5 units.

21250 Main Street (Lot A) will be developed with 11 units and 24 parking spaces: 22 spaces for the residential (2/unit) and 2 guest parking spaces.

21240 Main Street (Lot B) will be developed with 8 units and 18 parking spaces: 16 spaces for the residential (2/unit) and 2 guest parking spaces.

The proposal includes 38 parking spaces, two will be ADA accessible parking spaces. The proposal also includes 4 guest parking spaces, one will be an ADA accessible parking space.

Prior to obtaining building permits, reciprocal parking easements will be recorded to both properties ensuring that all 42 parking spaces are available to both parcels in perpetuity.

Bicycle parking will be provided on Lot B and available to both buildings.

Both the City's Traffic Engineer and the Los Angeles County Fire Department have reviewed and cleared the project prior to tonight's public hearing.

Buildings and Architecture

As shown in Figure C - Conceptual Rendering, the project is designed in a modern architectural style combining multiple roof elevations, smooth stucco and varying types of fiber cement composite panels. A belly band has been added to the façade between the first and second floors, thus allowing for color variation and to provide vertical articulation in the façade. The building is capped with an anodized aluminum coping. Reveals extend from the transoms and stiles of the windows to provide shadowing. To add additional visual interest at the corner of Main Street and 213th Street, porcelain tiles have been included above the entry lobby for Building A.







NORTHWEST RENDERING

Figure (C) Conceptual Rendering



Figure (D) Proposed Elevations

Fence

A six-foot-high, decorative split-face block wall, with flat precision cap is proposed along the eastern property line. The wall will include 6 feet 6-inch-high split-face block pilasters, with 18-inch square precast cap.

Open Space

6,164 square feet of open space will be provided, which equates to 27% of the gross lot area. Open space will be provided through private (balconies), useable (courtyards), and common (pathways and setbacks). The useable open space is located on the second floor of each building.

Signage

One sign which identifies the project, "Carson Lofts", shall be permitted per street frontage. Each sign shall be non-illuminated or reverse channel letters, wall mounted, and shall not exceed twenty-four (24) square feet. One address sign (street number only) shall also be allowed per building.

Landscaping

The Project proposes approximately 3,164 square feet of landscaping around the perimeter of the Project Site. A variety of drought tolerant ornamental shrubs and medium size trees, which would be varying in height, would be included as a part of the proposed landscaping. Landscaping and plantings to be provided along the site's eastern edge will offer a verdant privacy screen for adjacent residential uses. The irrigation system would be designed and constructed to meet and/or exceed Model Water Efficient Landscape Ordinances (MWELO).

V. Specific Plan, Zoning and General Plan Consistency

The proposed project is not consistent with the standards of the current Commercial General, Design Overlay (CG-D) zoning nor is it consistent with the current General Commercial, General Plan land use designation. The applicant proposes GPA No. 109-20 to change the General Plan land use designation to Urban Residential, which allows for residential densities up to 65 dwelling units per acre, to ensure consistency with the proposed Carson Lofts Specific Plan (SP No. 29-22), which would allow for a residential density of up to 40 units per acre within the specific plan area (the project area). According to the General Plan, the Urban Residential category would be implemented with a Specific Plan zone. The proposed project has a residential density of 36.5 units per acre (19 units/0.52 acres = 36.5), consistent with the maximum density allowable under the proposed Specific Plan.

A Specific Plan is a planning tool included in state law that allows cities to adopt different development standards than those in a specific zone. The proposed project proposes different development standards than those included in the existing CG-D zone, therefore, the applicant proposes the Carson Lofts Specific Plan (CLSP).

The project also proposes ZCC No. 184-21 to change the zoning to Carson Lofts Specific Plan (ZCC 184-21 and SP No. 29-22).

If these entitlements are approved, the proposed project will be consistent with the amended General Plan land use designation and the zoning designation, development standards, and allowable uses identified in the Specific Plan. The proposed project furthers General Plan Land Use Element goals including LU-6 (A sustainable balance of residential and non-residential development and a balance of traffic circulation throughout the City), LU-7 (Adjacent land uses that are compatible with one another), LU-9 (Eliminate

all evidence of property deterioration throughout Carson), LU-12 (Create a visually attractive appearance throughout Carson), and LU-15 Promote development in Carson which reflects the "Livable Communities" concepts.

VI. <u>CFD/DIF Discussion</u>

The proposed development is required to mitigate its impacts on city services. City adopted Community Facilities District (CFD No. 2018-01) and may adopt a similar community facilities district in the future to use instead of CFD No. 2018-01 (collectively referred to herein as the "CFD") to fund the ongoing costs of law enforcement, street and sidewalk maintenance, landscape maintenance, street sweeping and sidewalk cleaning, and other eligible impacts of the Project within the CFD (the CFD Services). A uniformed-standardized rate was adopted pursuant to Resolution No. 19-009 ("Resolution") and accompanying Fiscal Impact Analysis ("FIA") report.

The applicant, property owner, and/or successor to whom these project entitlements are assigned ("Developer") shall be responsible to establish a funding mechanism to provide an ongoing source of funds for the ongoing services comparable to the uniformed-standardized rate established in the Resolution and FIA report. Based on the adopted Resolution, the subject property falls under "Residential – All Others" rate at \$1,076.94 per unit per year through June 30, 2023. Based on a 19-unit development, the current estimated annual amount for ongoing services is \$20.461.86, subject to annual adjustments.

Interim Development Impact Fee

The applicant shall be responsible for payment of a one-time development impact fee at the applicable rate, currently \$18,485.56 per unit for Fiscal Year 2022-23, effective July 1, 2022, through June 30, 2023.

If paid during Fiscal Year 2022-23, the proposed development would be responsible for development impact fees of \$351,225.64 (19 new units X \$18,485.56 = \$351,225.64. If the Project increases or decreases in size, the IDIF Amount will be adjusted accordingly at the same rate.

VII. Environmental Review and CEQA Finding

Planning Staff, working with the City's Environmental Consultant, has reviewed the potential environmental impacts of the proposed project pursuant to the California Environmental Quality Act (CEQA). Following an initial study, a Draft Mitigated Negative Declaration (State Clearinghouse #202260615) was prepared and made available for a public review period from June 27, 2022, through July 27, 2022. No public comments were received, including none suggesting that an Environmental Impact Report (EIR) should be prepared. A Notice of Intent to adopt a Mitigated Negative Declaration was prepared and issued in compliance with CEQA. A final Mitigated Negative Declaration and a Mitigation Monitoring and Reporting Program have now been prepared for the Commission's review. The Mitigated Negative Declaration, which reflects the independent judgment of the City as lead agency, found potentially significant impacts to air quality, cultural resources, geology and soils, hazards and hazardous materials, noise, and tribal cultural resources. With the inclusion of the proposed mitigation measures, which are included as project conditions of approval, all potential environmental impacts are mitigated to the maximum extent feasible and below a level of significance.

VIII. Public Outreach

On August 27, 2021, the applicant sent mailers to sixteen (16) residences surrounding the project site. The mailer provided an overview of the proposed project and noted that the applicant and his team would be visiting each of them in person on Saturday, September 11, 2021 between 10:00 a.m. and 12:00 p.m. Outreach to 16 residences was designed to introduce the applicant's team to the neighbors, discuss the project, and learn about any community concerns.

The outreach effort resulted in the applicant:

- Meeting with and presenting the project to eight (8) neighbors.
- Missing in person contact but left behind information packets for six (6) neighbors.
- Missing in person contact due to "No Trespassing" sign with two (2) neighbors.

The residents' primary concerns related to affordable housing detracting from the neighborhood, overcrowding, reduced property values, privacy, parking, traffic and access. Positive comments related to removing a blighted, vacant lot with much needed housing with an architectural design that improves the high visibility corner.

On August 25, 2022, the applicant held a virtual Zoom community meeting with one attendee, who is the property owner for 117 E 213th Street. The one attendee noted that he liked the project and supported developing the vacant lot. He also noted the proposed architectural style would be a welcome addition to the area. He was concerned, however, if affordable housing would be included in the project. Since only market rate apartments (no deed restricted affordable housing units) are proposed, his concern was alleviated.

IX. Public Notice

Notice of public hearing was posted to project site on September 15, 2022. The public hearing notice was posted in the newspaper and mailed to property owners and occupants within a 750' radius by September 15, 2022. The agenda was posted at City Hall 72 hours prior to the Planning Commission meeting.

X. Recommendation

That the Planning Commission:

ADOPT Resolution No. 22-__, entitled "A RESOLUTION OF THE PLANNING COMMISSION OF THE CITY OF CARSON APPROVING SITE PLAN AND DESIGN REVIEW NO. 1832-20 AND RECOMMENDING THAT THE CITY COUNCIL ADOPT A MITIGATED NEGATIVE DECLARATION AND MITIGATION MONITORING AND REPORTING PROGRAM AND APPROVE GENERAL PLAN AMENDMENT NO. 109-20, ZONE CHANGE NO. 184-21, AND SPECIFIC PLAN NO. 23-20 FOR A 19-UNIT MULTIPLE-FAMILY RESIDENTIAL DEVELOPMENT AT 21240-21250 MAIN STREET, APNS 7334-002-007 & 008."

XI. Exhibits

- 1. Draft Resolution
 - A. Legal Description
 - B. Conditions of Approval
- 2. Development Plans

- 3. Specific Plan
- 4. Mitigation Monitoring and Reporting Program5. Final Initial Study/Mitigated Negative Declaration

Prepared by: McKina Alexander, Associate Planner



TUESDAY, SEPTEMBER 27, 2022

701 East Carson Street, Carson, CA 90745 6:30 p.m., Via Zoom

MINUTES OF THE PLANNING COMMISSION

Members: Vice Chair: Chris Palmer Louie Diaz Frederick Docdocil

Carlos Guerra Del Huff Jaime Monteclaro

Dianne Thomas Karimu Rashad Richard Hernandez

Alternates: (VACANT) DeQuita Mfume Leticia Wilson

Staff: Planning Manager: Betancourt

Planning Secretary: (VACANT)

Assistant City Attorney: Jones

"In accordance with the Americans with Disabilities Act of 1990, if you require a disability related modification or accommodation to attend or participate in this meeting, including auxiliary aids or services, please call the Planning Department at 310-952-1761 at least 48 hours prior to the meeting." (Government Code Section 54954.2)

1. CALL TO ORDER

Vice Chair Palmer called the meeting to order at 6:36 p.m.

2. ROLL CALL

Commissioner Present: Palmer, Diaz, Docdocil, Guerra, Hernandez, Huff, Thomas, Wilson

Absent: Monteclaro (A), Rashad (A), Mfume (EA)

Planning Staff: Naaseh, Betancourt, Alexander, Jones, Gonzalez, Rubio

3. ORAL COMMUNICATION FOR NON-PUBLIC HEARING ITEMS ON THE AGENDA

The public may at this time address the members of the Planning Commission on any non-public hearing items on the agenda. Separate public comment periods will be provided for public hearing items during the respective hearings. Speakers are requested to limit their comments to no more than three minutes each, speaking once. *(see below)

None.

4. ORAL COMMUNICATION FOR MATTERS NOT ON THE AGENDA

The public may at this time address the members of the Planning Commission on any non-agendized items within the jurisdiction of the Planning Commission. No action may be taken on non-agendized items except as authorized by law. Speakers are requested to limit their comments to no more than three minutes each, speaking once. *(see below) None.

DUE TO CORONA VIRUS COVID-19, NO MEMBERS OF THE PUBLIC WILL BE ALLOWED INTO CITY HALL DURING THE PLANNING COMMISSION MEETING. THE MEETING WILL BE CONDUCTED VIA REMOTE TELECONFERENCING USING THE ELECTRONIC "ZOOM" APPLICATION. TO FACILITATE PUBLIC PARTICIPATION, HOWEVER, ACCESS

TO THIS MEETING WILL BE AVAILABLE TELEPHONICALLY USING FOLLOWING CALL-IN INFORMATION:

Join Zoom Meeting:

Meeting ID: 845 2525 5858

Passcode: 516138

Dial by your location: +1 669 900 6833 US

Any members of the public wishing to provide public comment for this meeting may do so as follows:

- 1. Live via Zoom Application. Members of the public wishing to provide public comment in real-time may join the Zoom meeting remotely via telephone to provide their public comment live during the applicable public comment period with their audio presented to the Planning Commission. Members of the public wishing to do so are requested to email planning@carsonca.gov in advance, providing their real name and the phone number they will use to call in from. For further details or questions, please email planning@carsonca.gov.
- 2. Email: You can email comments to planning@carsonca.gov before the meeting. Please identify the Agenda item you wish to address in your comments. Your comments will be read into the record. The cut-off time to receive any email communications is 3:00 p.m. on the day of the meeting. If you missed the deadline, you may call to make a public comment during the meeting.
- 3. Telephone: You can record your comments at (310) 952-1761 before the meeting. Please identify the Agenda item you wish to address in your comments. Your comments will be read into the record. The cut-off time to receive any email communications is 3:00 p.m. on the day of the meeting. If you missed the deadline, you may call to make a public comment during the meeting.
- 4. Box outside of City Hall: You can provide hand-written comments by dropping off a note at the box located in front of City Hall (701 East Carson Street) on the date of the meeting before the meeting starts. Please identify the Agenda item you wish to address in your comments. Your comments will be read into the record. The cut-off time to receive any email communications is 3:00 p.m. on the day of the meeting. If you missed the deadline, you may call to make a public comment during the meeting.

NOTE: Members of the public wishing to observe the meeting live without providing public comment will be able to do so by watching it on the City's PEG television channel (Channel 35 on Charter or Channel 99 on AT&T for Carson residents) or via live streaming on the City's website, http://ci.carson.ca.us/).

5. CONSENT CALENDAR

A. Minutes Approval: August 30, 2022

Commissioner Diaz (1st) Motion to approve, Commissioner Guerra (2nd); Motion passed with 7-1 (Huff Abstained).

Commissioner Thomas ask the applicant if there are any plans to consolidate both hotels and asked about trucks parking in the back

Applicant Steve Rigor, Arris Studio Architects – responded that there's no plans to change the façade of the hotel at this time. Mr. Rigor and Owner Patel no plans to make room for truck parking at this time. The back alley that they are now using won't be there.

Commissioner Diaz (1st) motion, Commissioner Thomas (2nd), Motion passed with 8-0. Approved staff's recommendation with changes to Condition of Approval to #5, 14,15 per Assistant Attorney Jones. Applicant approved amended changes.

C. General Plan Amendment (GPA) No. 109-20, Zone Change (ZCC) No. 184-21, Specific Plan (SP) No. 23-20, Site Plan Design Review Overlay (DOR) No. 1832-20

Applicant: David Blumenthal, AICP

Sagecrest Planning + Environmental 2400 E. Katella Avenue, Suite 800

Anaheim, CA 92806

Property Owner: Kim Family Trust

P.O. Box 44

Palos Verdes Estates, CA 90274

Request: Consider approval of a proposed 19-unit multiple-family residential

development on two vacant parcels.

Property Involved: 21240-21250 Main Street

Associate Planner Alexander had a PowerPoint presentation.

Commissioner Guerra when I read the staff report there was a former gas station, does it require any remediation? Is there any timeline.

Jason Reynolds – A phase 2 environment assessment is required, it is one of the Conditions of Approval. Environmental assessment is completed prior to construction activities.

Applicant: David Blumenthal, AICP, Sagecrest Planning + Environmental, agree with everything on Conditions of Approval except number 72, this item may not make this project feasible.

Jeremy Davis – No comment was made.

Commissioner Diaz - would like to hear from the Engineer for underground utilities.

Engineer Kenneth Young – underground utilities are a standard condition and a cost estimate is \$100k to 150k. If it's not feasible we do a trust account to add money into an escrow account and when it gets to an amount the City will do the undergrounding of utilities.

Vice Chair Palmer re-opened the Public Hearing for Commissioner Thomas to ask another question and Public to speak.

Commissioner Thomas asked if condition #72 remains will the project be feasible.

Applicant David Blumenthal will not be committing if they are completing the project or not if this condition.

Carson Resident Luisa Chalco opposed to this item. New construction will be above the residential house, she only received notice for this meeting and did not get any other information on this item, this is a very busy corner, there's no parking around this area and there's heavy traffic from 6:00 to 8:00 a.m. it's almost impossible to go through. You are not improving you are damaging the community.

Division Secretary Gonzalez – for the record, I did not receive any emails or letters for this item.

Commissioner Hernandez - I have seen underground utilities improve the community. If there's an accident, it doesn't interrupt anybody else.

Commissioner Guerra – in addition to what Commissioner Hernandez said, esthetical pleasing is not only important but traffic collisions hitting the poles causing additional hazards and inconvenience. Hopefully the applicant owner changes his mind and this will help his project.

Commissioner Diaz (1st) motion, Commissioner Hernandez (2nd), Motion passed with 8-0 Approved Staff's recommendation of proposed 19-unit multiple-family residential development on two vacant parcels without removal of Conditions of Approval #72.

D. Site Plan Design Review Overlay (DOR) No. 1891-22

Applicant: Link Logistics

3333 Michelson Drive, Suite 725

Irvine, CA 92612

Property Owner: B8 Alondra Industrial Owner LLC

233 South Wacker Drive, Suite 3400

Chicago, IL 60606

Request: Consider approval of two new tilt-up warehouse building totaling


288,821 square-feet with 52 dock doors, 210 parking spaces and

39 trailer parking spaces.

Property Involved: 100 W. Alondra Boulevard

Betancourt asked that this item be taken out of order since the applicant requested a continuance. Palmer asked for this item to be taken out of order. Diaz moved to take this Item out of order, 2nd by Commissioner Huff. A consensus vote was done. Vote 8-0

CARSON LOFTS

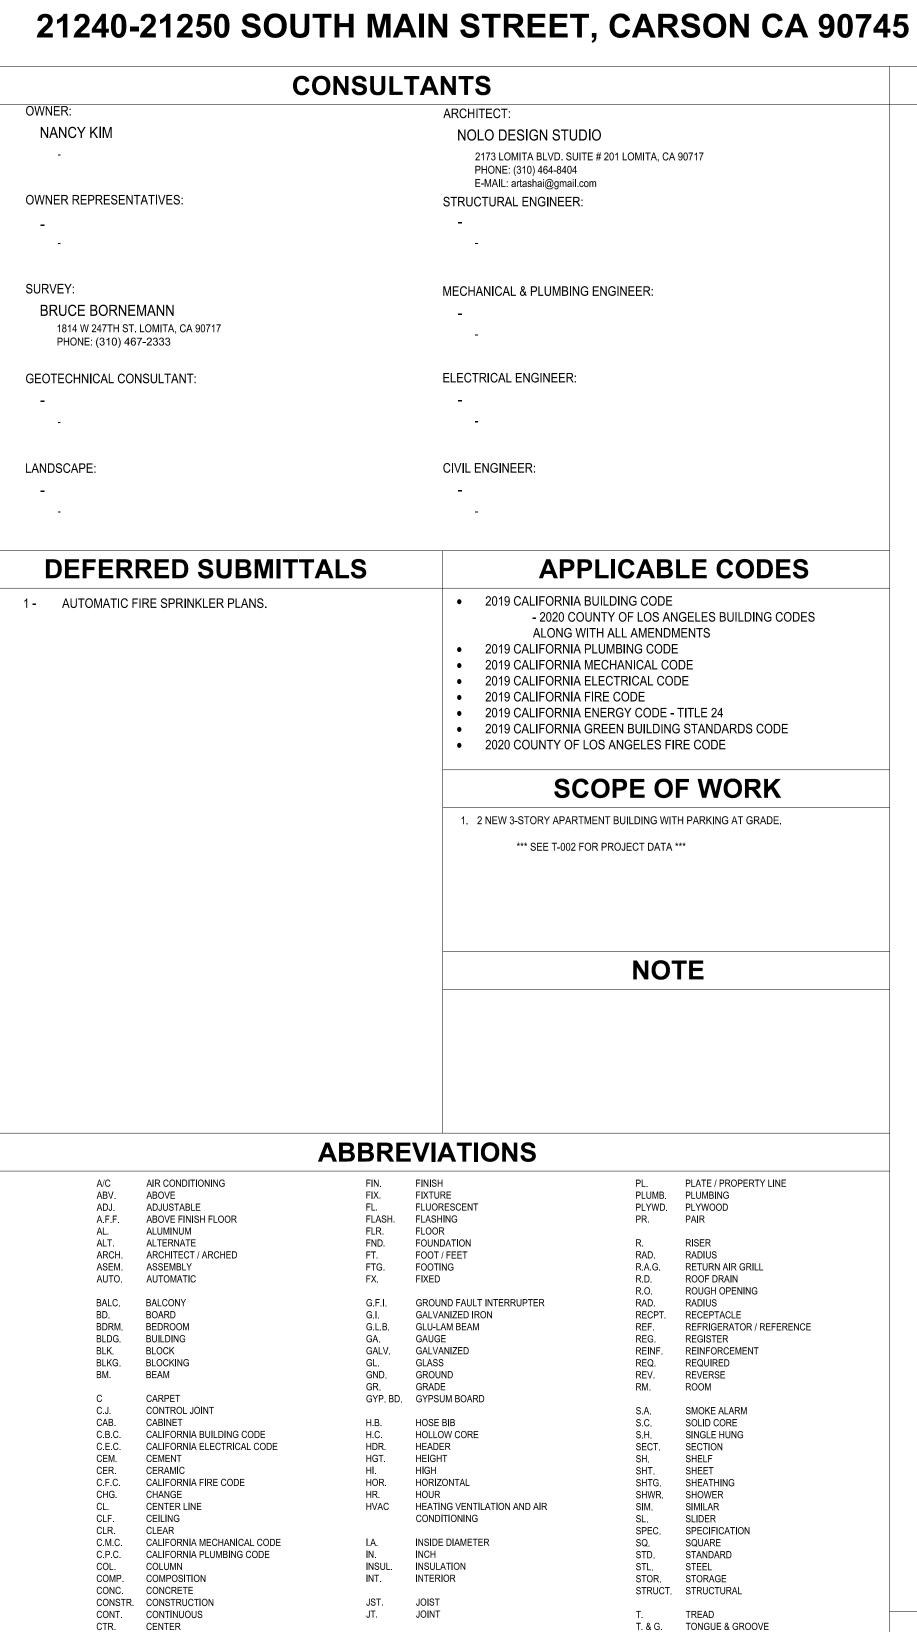

KIT. KITCHEN

MAS. MAT. MAX.

N.T.S.

O.A. O / OBS. OFF. OPNG.

LAVATORY

MATERIAL

MECHANICAL

MANUFACTURER

MISCELLANEOUS

METAL THRESHOLD

NOT IN CONTRACT

NOT TO SCALE

NATURAL

NUMBER

OBSCURE

OFFICE

OPENING

P.LAM. PLASTIC LAMINATE

PERIM PERIMETER
PERP. PERPENDICUL
PH. PHONE

OPPOSITE

PANTRY / POLE

PERPENDICULAR

PRESSURE TREATED

ON CENTER

OUTSIDE DIAMETER

MEMBRANE

MINIMUM

CASED OPENING

DOUGLAS FIF

DIAGONAL

DISPOSAL

DOWN

DOOR

DIMENSION

DOWNSPOUT

ELECTRIC

ENCLOSURE

EQUIPMENT

EXHAUST

EXPOSED

EXTERIOR

FACE OF CONCRETE

FACE OF FINISH

FACE OF MASONRY

ENCL.

EQUIP.

DISHWASHER

DOUBLE DETAIL T.B. T.O.C.

U.B.C.

V.T.R.

VENT. VERT. VEST.

VOL.

W.R.

TOP OF CURB

TOP OF WALL

TEMPERED

TRANSOM

TYPICAL

TRANSFORMER

UNIFORM BUILDING CODE

UNLESS NOTED OTHERWISE

VENT THROUGH ROOF

VENTILATION

WATER HEATER

WALK IN CLOSET

WATER RESISTANT

VERTICAL

VESTIBULE

VOLUME

WOOD

WEIGHT


WATERPROOF


UNDERWRITERS LABORATORY

T.O. DR. TOP OF DOOR T.O.M. TOP OF MASONRY
T.O.P. TOP OF PLATE
T. SHTG. TOP OF SHEATHING

T.O. WIN. TOP OF WINDOW

THICK

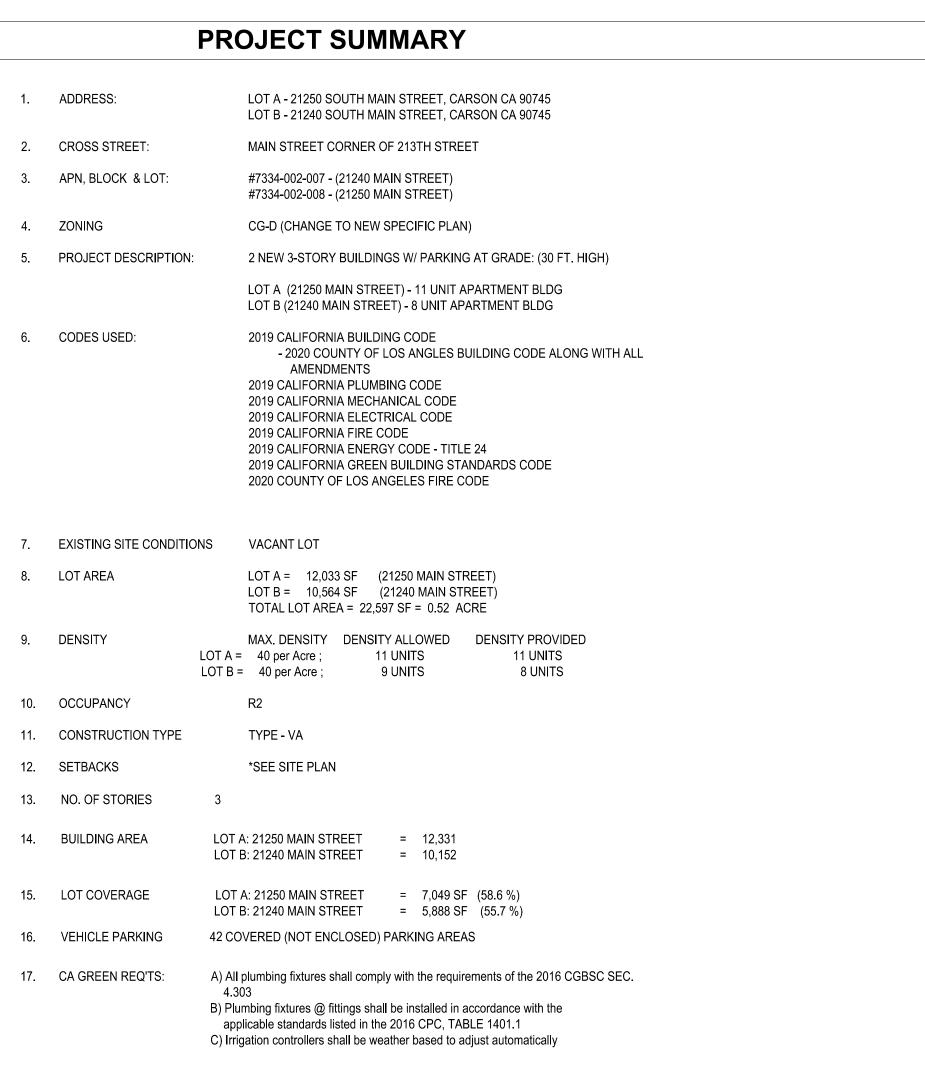

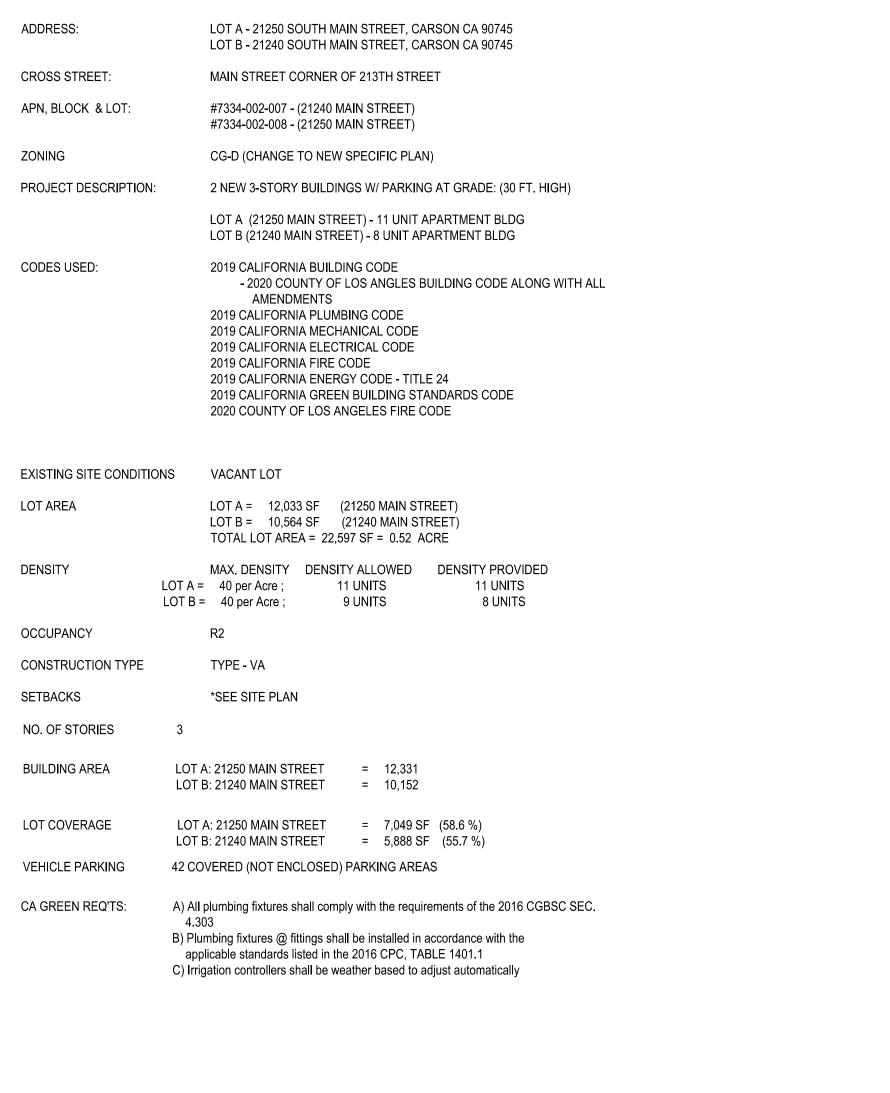



2173 LOMITA BLVD. #201 LOMITA CALIFORNIA 90717

Architect:

ART ASHAI, AIA

2173 LOMITA BLVD. #201 **LOMITA CALIFORNIA 90717** PHONE: 424-263-5888 email: artashai@gmail.com

This drawing is the property of DESIGNER, and it is not to be reproduced or copied in whole or part. It is not to be used for any other project and is to be returned upon request. The DESIGNER retains

STREET

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21240 MAIN STREE

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NANCY KIM

FIRST FLOOR OVERALL PLAN A-101 A-102 SECOND FLOOR OVERALL PLAN A-103 THIRD FLOOR OVERALL PLAN A-104 **ROOF PLAN** A-111 **BUILDING A - UNIT PLANS**

OPEN SPACE PLAN

ARCHITECTURAL:

TITLE SHEET

SITE PLAN

PROJECT DATA

BUILDING A - UNIT PLANS **BUILDING A - UNIT PLANS BUILDING B - UNIT PLANS** A-122

T-002

A-001

A-003

BUILDING B - UNIT PLANS **BUILDING B - UNIT PLANS** BUILDING B - UNIT PLANS A-201 ELEVATIONS A-201.1 **BLOW-UP ELEVATIONS**

A-202 **ELEVATIONS** A-202.1 RENDERINGS A-301 SECTIONS A-302 SECTIONS

LANDSCAPE:

GROUND FLOOR CONCEPTUAL PLAN SECOND FLOOR CONCEPTUAL PLAN L.1.1 L.2.0 PLANT PALETTE


PROJECT INFORMATION:

Project Title: **CARSON APARTMENTS** 21240 Main Street Carson, CA 90745

21250 Main Street Carson, CA 90745

LEGAL DESCRIPTION

APN: 7334-002-007 APN: 7334-002-008

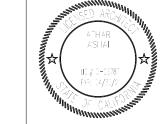

VICINITY MAP

SHEET INDEX

GRADING AND DRAINAGE TITLE SHEET

GRADING AND DRAINAGE PLAN

GRADING AND DRAINAGE SECTION

C-001

3 OF 3


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MECHANICAL:


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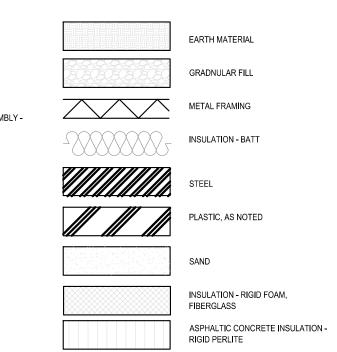



NOT IN CONTRACT BY OTHERS


(N.I.C. HAS TO BE WRITTEN

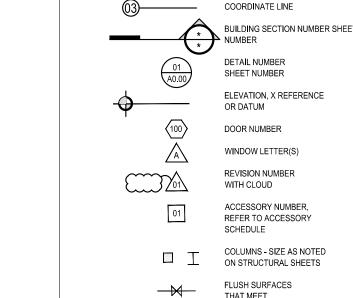

SYMBOLS(PARTIAL LIST)

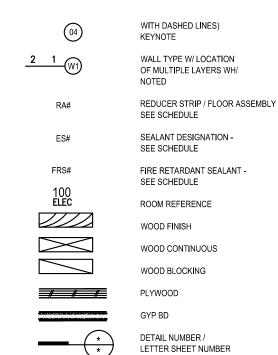

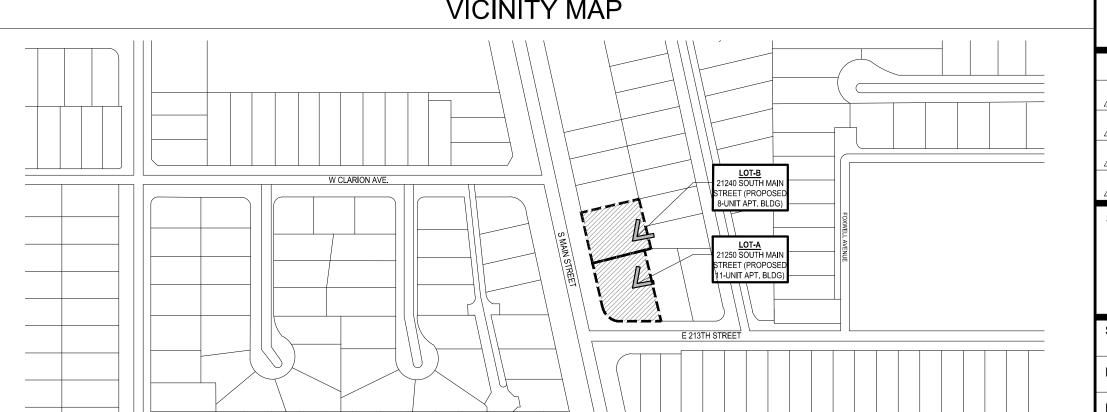

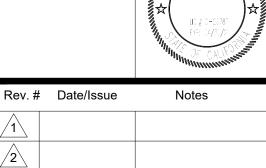

Sheet Title:

TITLE SHEET

AS NOTED J-1908 Date: Aug2021 Sheet Number : Drawn: arkihaus Check'd: CTV/RRJ

RECIPROCAL EASEMENT AGREEMENT (REA)

- A REA for reciprocal access, parking, utilities, and waste disposal shall be recorded against both properties (APN 7334-002-007 and APN 7334-002-007) prior to the issuance of building permits.
- The City of Carson shall review and approve the REA prior to recordation.
- The REA shall take effect immediately upon recordation.
- The City of Carson shall be a named third-party beneficiary of the REA. The REA shall not be amended or terminated without prior written

PROJECT AREAS

BUILDING INFORMATION:

21250 Main Street, Carson CA

Lot Area:

		,	
Max. Den	sity:	40 per Ac.	
Density A	llowed:	11 units	
Density P	roposed:	11 units	
Unit#	Type	Area	Balcony
101	2B + 2Ba	945	85
201	2B + 2Ba	980	74
202	2B + 2Ba	977	66
203	2B + 2Ba	1,037	76
204	2B + 2Ba	1,090	78
205	2B + 2Ba	1,054	88
301	2B + 2Ba	980	74
302	2B + 2Ba	977	66
303	2B + 2Ba	1,037	76
304	2B + 2Ba	1,090	78
305	2B + 2Ba	1,054	88
	TOTAL	11,221	849
Common	1,716		
			0.505

12,033 sf

Parking required: 2.2 / unit Parking provided:

Common Floor Area 1st Floor = 540 SF 2nd Floor = 420 SF 3rd Floor = 150 SF TOTAL = 1,110 SF

Total open space

Total Bldg. Floor Area_ 11,221 + 1,110 = 12,331 SF

Covered (not enclosed) Parking Area = 5,714 SF

Lot Coverage = 7,049 SF (58.5%)

2,565

21240 Main Street, Carson CA

10,564 sf Lot Area: Max. Density: 40 per Ac. Density Allowed: 9 units Density Proposed: 8 units

Unit#	Type Area	Balcony
101	2B + 2Ba 1,042	92
201	2B + 2Ba 1,081	80
202	2B + 2Ba 1944	69
203	2B + 2Ba 1,031	54
204	2B + 2Ba 1,025	66
301	2B + 2Ba 1,081	80
302	2B + 2Ba 944	69
303	4B + 4Ba 2,061	120

9,209 Common open space 3,308 Total open space

Parking required: 2.2 / unit Parking provided:

Common Floor Area 1st Floor = 539 SF 2nd Floor = 324 SF 3rd Floor = 80 SF TOTAL = 943 SF

Total Bldg. Floor Area

Covered (not enclosed) Parking Area = 4,190 SF

Lot Coverage = 5,888 SF (55.7%)

BUILDING INFORMATION:

LOT AREA =

MAX DENSITY = 40 UNITS / ACRE

DENSITY ALLOWED = 20.8 UNITS (20 UNITS)

DENSITY PROPOSED = 19 UNITS 4,394 SF

TOTAL OPEN SPACE = 5,873 SF (309 SF / UNIT)

24 + 18 = 42 SPACES (INCLUDING 4 H/C)

PROPOSED LOT COVERAGE = 7,049 + 5,888 = 12,937 SF (57.25%)

PROPOSED BUILDING FLOOR AREA = 22,483 SF

PROPOSED FAR =

(MEASURED TO ROOF LVL.)

Jnit#	Type	Area	Balcony
101	2B + 2Ba	1,042	92
201	2B + 2Ba	1,081	80
202	2B + 2Ba	1944	69
203	2B + 2Ba	1,031	54
204	2B + 2Ba	1,025	66
301	2B + 2Ba	1,081	80
302	2B + 2Ba	944	69
303	4B + 4Ba	2,061	120

9,209 + 943 = 10,152 SF

22,597 (0.52 ACRES)

COMMON OPEN SPACE = PRIVATE OPEN SPACE = 1,479 SF

PARKING REQUIRED = 19 x 2.2 = 41.8 = 42 SPACES

PARKING PROPOSED =

1.0 PROPOSED BLDG. HT. = 39 FT.



DESIGN STUDIO

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ART ASHAI, AIA

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2173 LOMITA BLVD. #201 LOMITA CALIFORNIA 90717

email: artashai@gmail.com

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& 21250 MAIN STREET

21240 MAIN STREET

NANCY KIM


Architect:

LOMITA CALIFORNIA 90717

Project Title: CARSON APARTMENTS 21240 Main Street Carson, CA 90745

21250 Main Street Carson, CA 90745

LEGAL DESCRIPTION APN: 7334-002-007

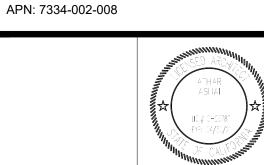


Rev.#	Date/Issue	Notes	
1			
2			
3			
4			

PROJ. AREAS AND SUMMARY

Check'd: CTV/RRJ

Job Number : J-1908 AS NOTED Date: Aug2021 Sheet Number: Drawn: arkihaus

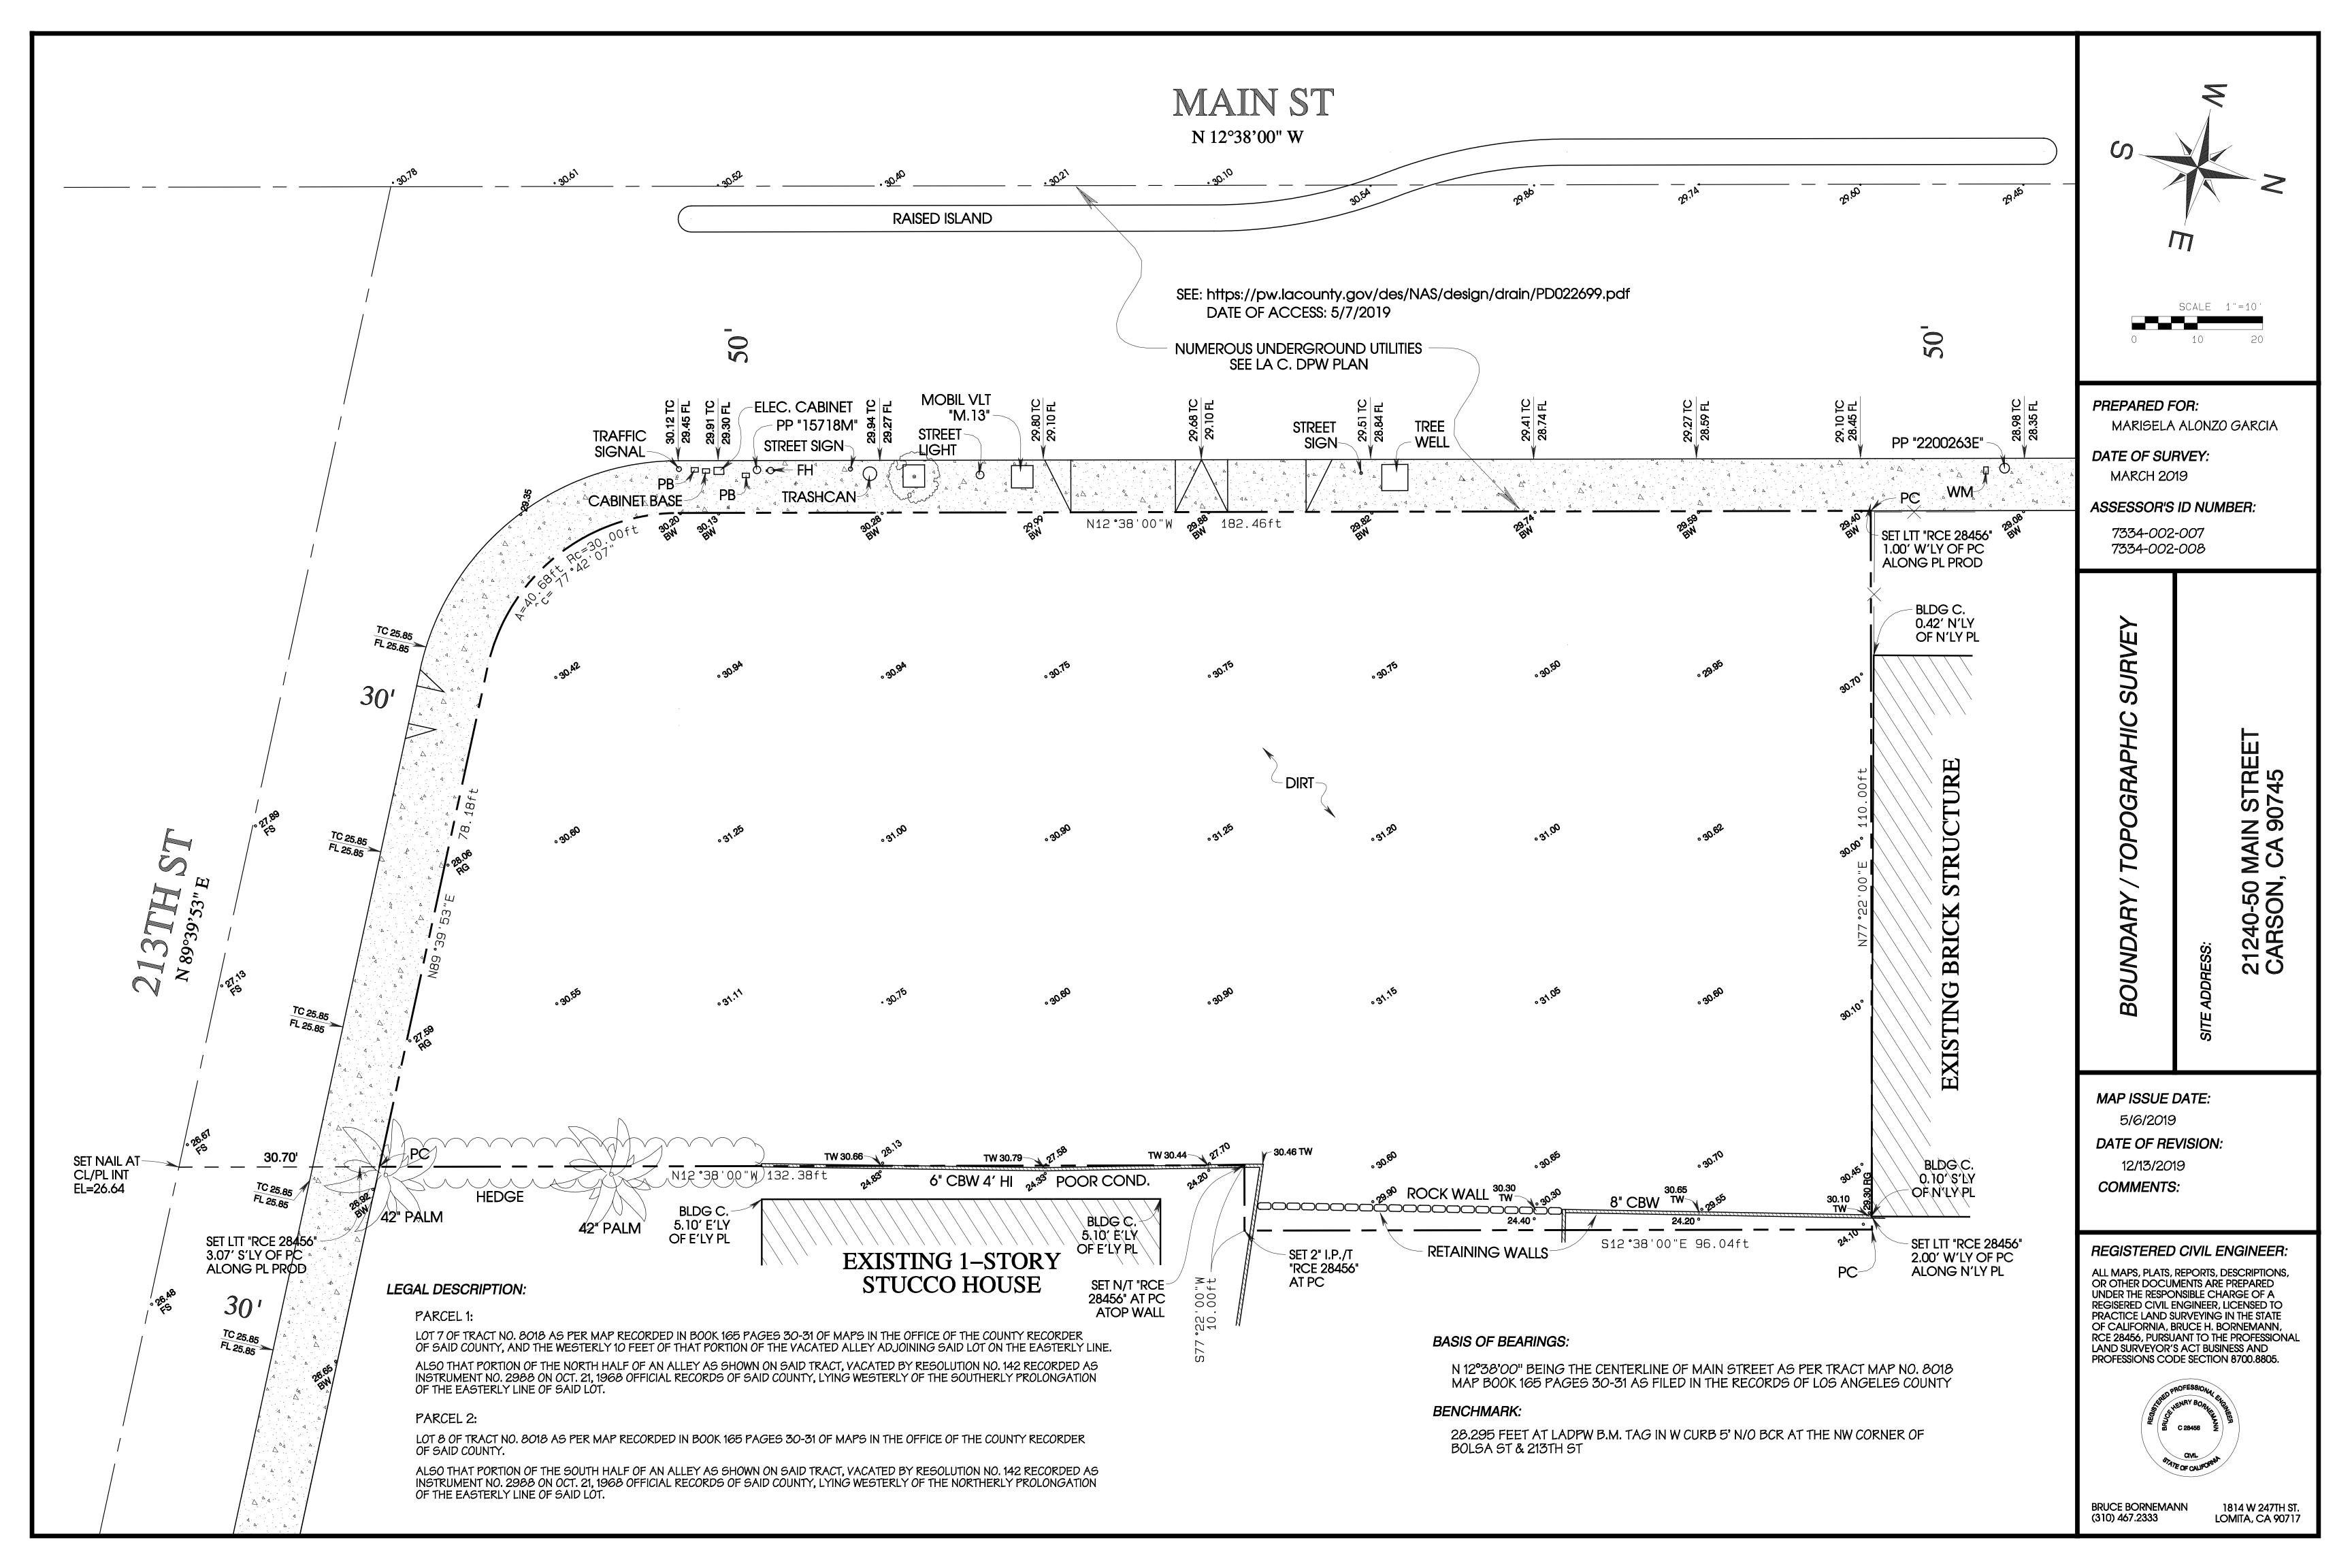

PROJECT INFORMATION:

WATER PURVEYOR: CALIFORNIA WATER SERVICE COMPANY TOTAL LANDSCAPE AREA: 3164 SQUARE FEET

PARCEL INFORMATION: 21240 MAIN STREET & 21250 MAIN STREET CARSON, CA 90745

A.P.N. 7334-002-007 A.P.N. 7334-002-008

GENERAL NOTES:

1. OWNER TO MAINTAIN LANDSCAPE AND IRRIGATION SYSTEM

2. STREET TREES WITHIN THE PUBLIC RIGHT-OF-WAY ARE TO BE PLANTED PER APPROVED STREET IMPROVEMENT PLANS.

3. ALL HARDSCAPES, RETAINING WALLS, SWIMMING POOLS, AND/OR BLOCK WALLS MUST BE REVIEWED AND APPROVED UNDER A SEPARATE PERMIT.

4. ALL PLANTS ARE IN COMPLIANCE WITH MODEL WATER EFFICIENT LANDSCAPE ORDINANCE (MWELO).

5. CONTRACTOR TO PROTECT AND PRESERVE IN PLACE ALL EXISTING SURVEY MONUMENTS. ANY MONUMENT DISTURBED SHALL BE RESET BY A LICENSED LAND SURVEYOR AND THE APPROPRIATE CORNER RECORD MUST BE FILED WITH THE COUNTY OF LOS ANGELES.

6. TREE CANOPIES ARE SHOWN AT FULL MATURITY.

7. AUDIT SHALL BE IN ACCORDANCE WITH THE LATEST STATE OF CALIFORNIA LANDSCAPE WATER MANAGEMENT PROGRAM AS DESCRIBED IN THE LATEST LANDSCAPE IRRIGATION AUDITOR HANDBOOK. THE LANDSCAPE IRRIGATION AUDITS TO BE CONDUCTED BY A QUALIFIED INDIVIDUAL AND THE AUDIT SCHEDULE SHALL BE CONDUCTED AT LEAST ONCE EVERY FIVE YEARS IN ACCORDANCE WITH THE REQUIREMENTS OF TITLE 20, DIVISION 1 OF THE LOS ANGELES COUNTY CODE.

8. TOTAL PROPOSED LANDSCAPE AREA: 3164 S.F.

9. TOTAL TURF AREA = 0 S.F. IS 0% OF TOTAL LANDSCAPE AREA.

10. TOTAL DROUGHT TOLERANT LANDSCAPING AREA = 3164 S.F. IS 100% OF THE TOTAL PROPOSED LANDSCAPE AREA.

11. HYDROZONING IRRIGATION TECHNIQUES SHALL BE INCORPORATED INTO THE LANDSCAPE DESIGN.

12. THIS PROJECT REQUIRES A LANDSCAPE PERMIT. PRIOR TO FINAL, CERTIFICATION FROM A LICENSED LANDSCAPE ARCHITECT SHALL BE PROVIDED TO THE BUILDING OFFICIAL. FINAL CERTIFICATION CAN BE OBTAINED AT THE FOLLOWING: http://dpw.lacounty.gov/bsd/publications/index.cfm

SHEET INDEX


L.0 TITLE SHEET

L.1.0 CONCEPTUAL PLAN - GROUND FLOOR
L.1.1 CONCEPTUAL PLAN - SECOND FLOOR


L.1.1 CONCEPTUAL PL
L.2 PLANT PALETTE

Site Information	20 - 22 - 23 - 24 - 2							
			AIN ST. CARSON, C					
	Site Type →	Residential	Allowed ETAF:	0.55				
Annual	Eto (inches/yr) →	42.6						
Hydrozone or Planting Description	Plant Fac	tor (PF)	Irrigation Method	Irrigation Efficiency (IE)	ETAF (PF/IE)	Hydrozone Area (sqft.)	ETAF x Area	Estimated Total Water Use (gal./yr.)
Regular Landscap	e Areas							
1	0.3	Low	Bubbler	0.81	0.4	22	8	21:
2	0.3	Low	Bubbler	0.81	0.4	22	8	21:
3	0.3	Low	Drip	0.81	0.4	158	59	1,558
4	0.3	Low	Drip	0.81	0.4	478	177	4,675
5	0.3	Low	Bubbler	0.81	0.4	13	5	13:
6	0.3	Low	Drip	0.81	0.4	941	349	9,21
B1	0.3	Low	Bubbler	0.81	0.4	51	19	502
B2	0.3	Low	Drip	0.81	0.4	451	167	4,41
B3	0.3	Low	Bubbler	0.81	0.4	19	7	18
B4	0.3	Low	Drip	0.81	0.4	128	47	1,24
B5	0.3	Low	Drip	0.81	0.4	944	350	9,24
Special Landscape	Areas				SUBTOTAL →	3,227	1,196	31,589
special cariascape	- Files				1		0	
					1		0	
		-			1		0	
					1		0	
					SUBTOTAL →	0	0	0
							r Use (ETWU) →	31,589
							ance (MAWA) →	46,877
ETAF Calculations Regular Landscap		(1,196 3,227		Notes:		Efficient Worksheet	
	Average ETAF		0.37				California Code of le 23, Division 2,	
All Landscape Are	as Total ETAF x Area	v.	1,196			Chapter 2.7.	Model Water	
	Total Area		3,227			Efficient Lands	cape Ordinance	
	Sitewide ETAF		0.37					

SITE WATER USE CALCULATIONS

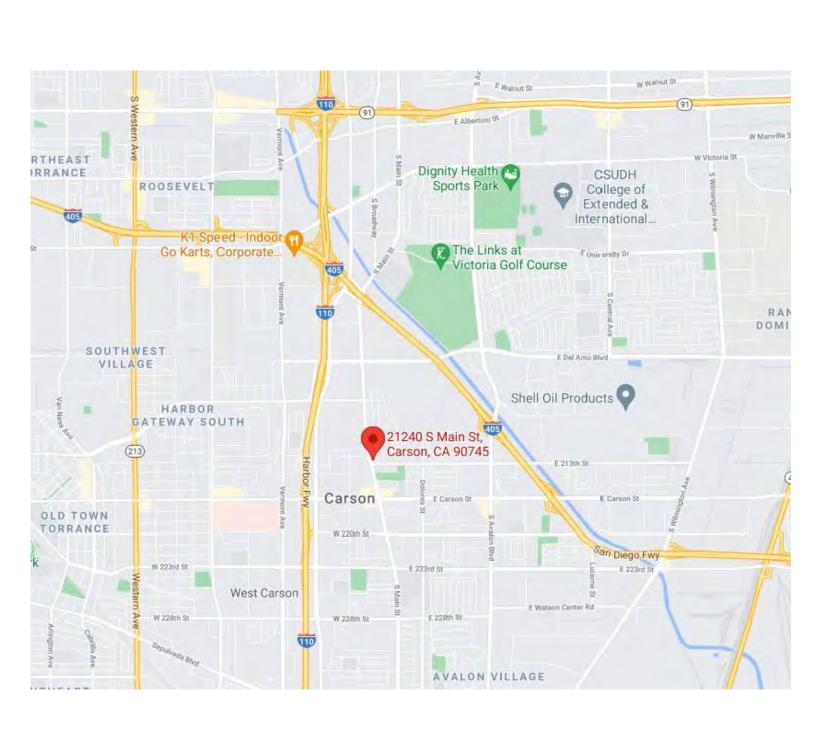


VICINITY MAP

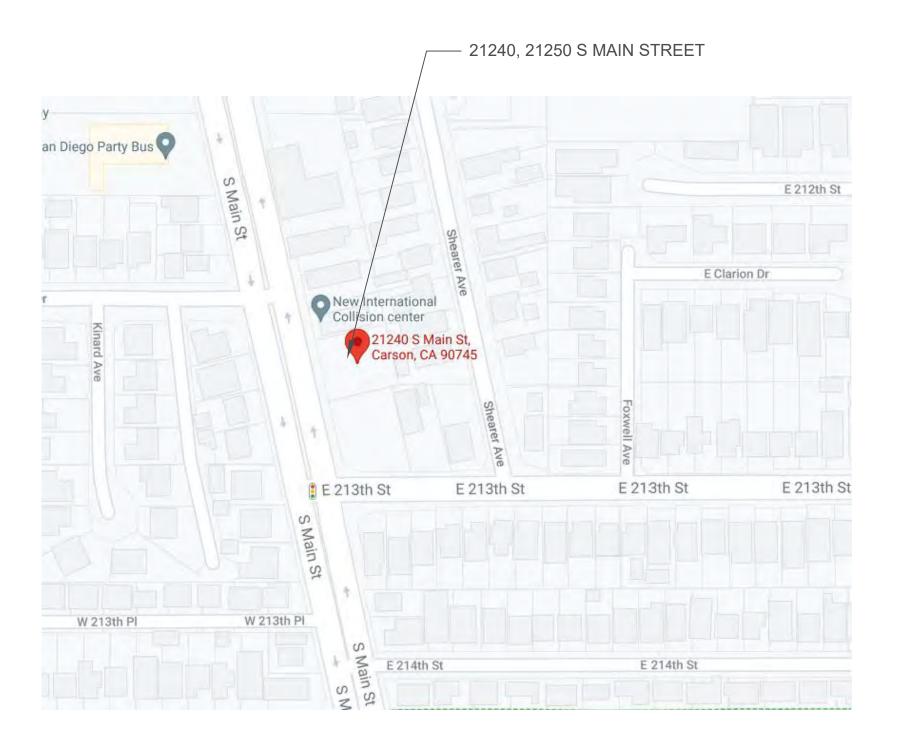

KEY MAP

CARSON LOFTS APARTMENTS 21240 MAIN STREET & 21250 MAIN STREET CARSON, CA 90745

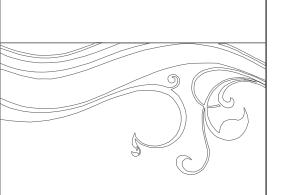

VIRIDITAS DESIGN

Landscape Architecture

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REVISIONS

DATE:

MAY 27, 2021

SCALE:


1/8" = 1'-0"

TITLE SHEET

L.0


PLANT LEGEND

	BOTANICAL NAME	COMMON NAME	SIZE AT 5 YRS.	PLANT TYPE	WUCOLS RATING						
* * * * * * * * * * * * * * * * * * *	ACHILLEA MILLEFOLIUM	COMMON YARROW	6" X 1'	GROUND COVER	0.3/L		RAPHIOLEPIS INDICA 'CLARA'	INDIAN HAWTHORN	4' X 4'	SHRUB	0.3/L
X	AGAVE ATTENUATA	FOXTAIL AGAVE	2' X 2'	SUCCULENT	0.3/L	•	WESTRINGIA 'BLUE GEM'	BLUE GEM COAST ROSEMARY	6' X 3'	SHRUB	0.3/L
	ALOE STRIATA	CORAL ALOE	2' X 18"	SUCCULENT	0.3/L		WESTRINGIA FRUTICOSA 'GREY BOX'	DWARF COAST ROSEMARY	3' X 3'	SHRUB	0.3/L
	CAREX DIVULSA (TUMULICOLA)	BERKELEY SEDGE	18" X 2'	GRASS LIKE	0.3/L		WESTRINGIA FRUTICOSA 'MUNDII'	MUNDI COAST ROSEMARY	18" X 3'	SHRUB	0.3/L
	GREVILLEA LANIGERA 'COASTAL GEM'	COASTAL GEM	1' X 3'	SHRUB	0.3/L		TREES				
	LANTANA 'NEW GOLD'	NEW GOLD LANTANA	3' X 3'	SHRUB	0.3/L		ARBUTUS MARINA - STANDARD FORM	STRAWBERRY TREE	15' X 12'	TREE	0.3/L
	LAURUS NOBILIS (SHRUB FORM)	SWEET BAY	8' X 4'	SHRUB	0.3/L		GEIJERA PARVIFLORA	AUSTRALIAN WILLOW	14' X 12'	TREE	0.3/L
	LOMANDRA 'NYALLA'	NYALLA MAT RUSH	3' X 3'	GRASS LIKE	0.3/L		PROPOSED PARKWAY TREE	N/A	N/A	TREE	N/A

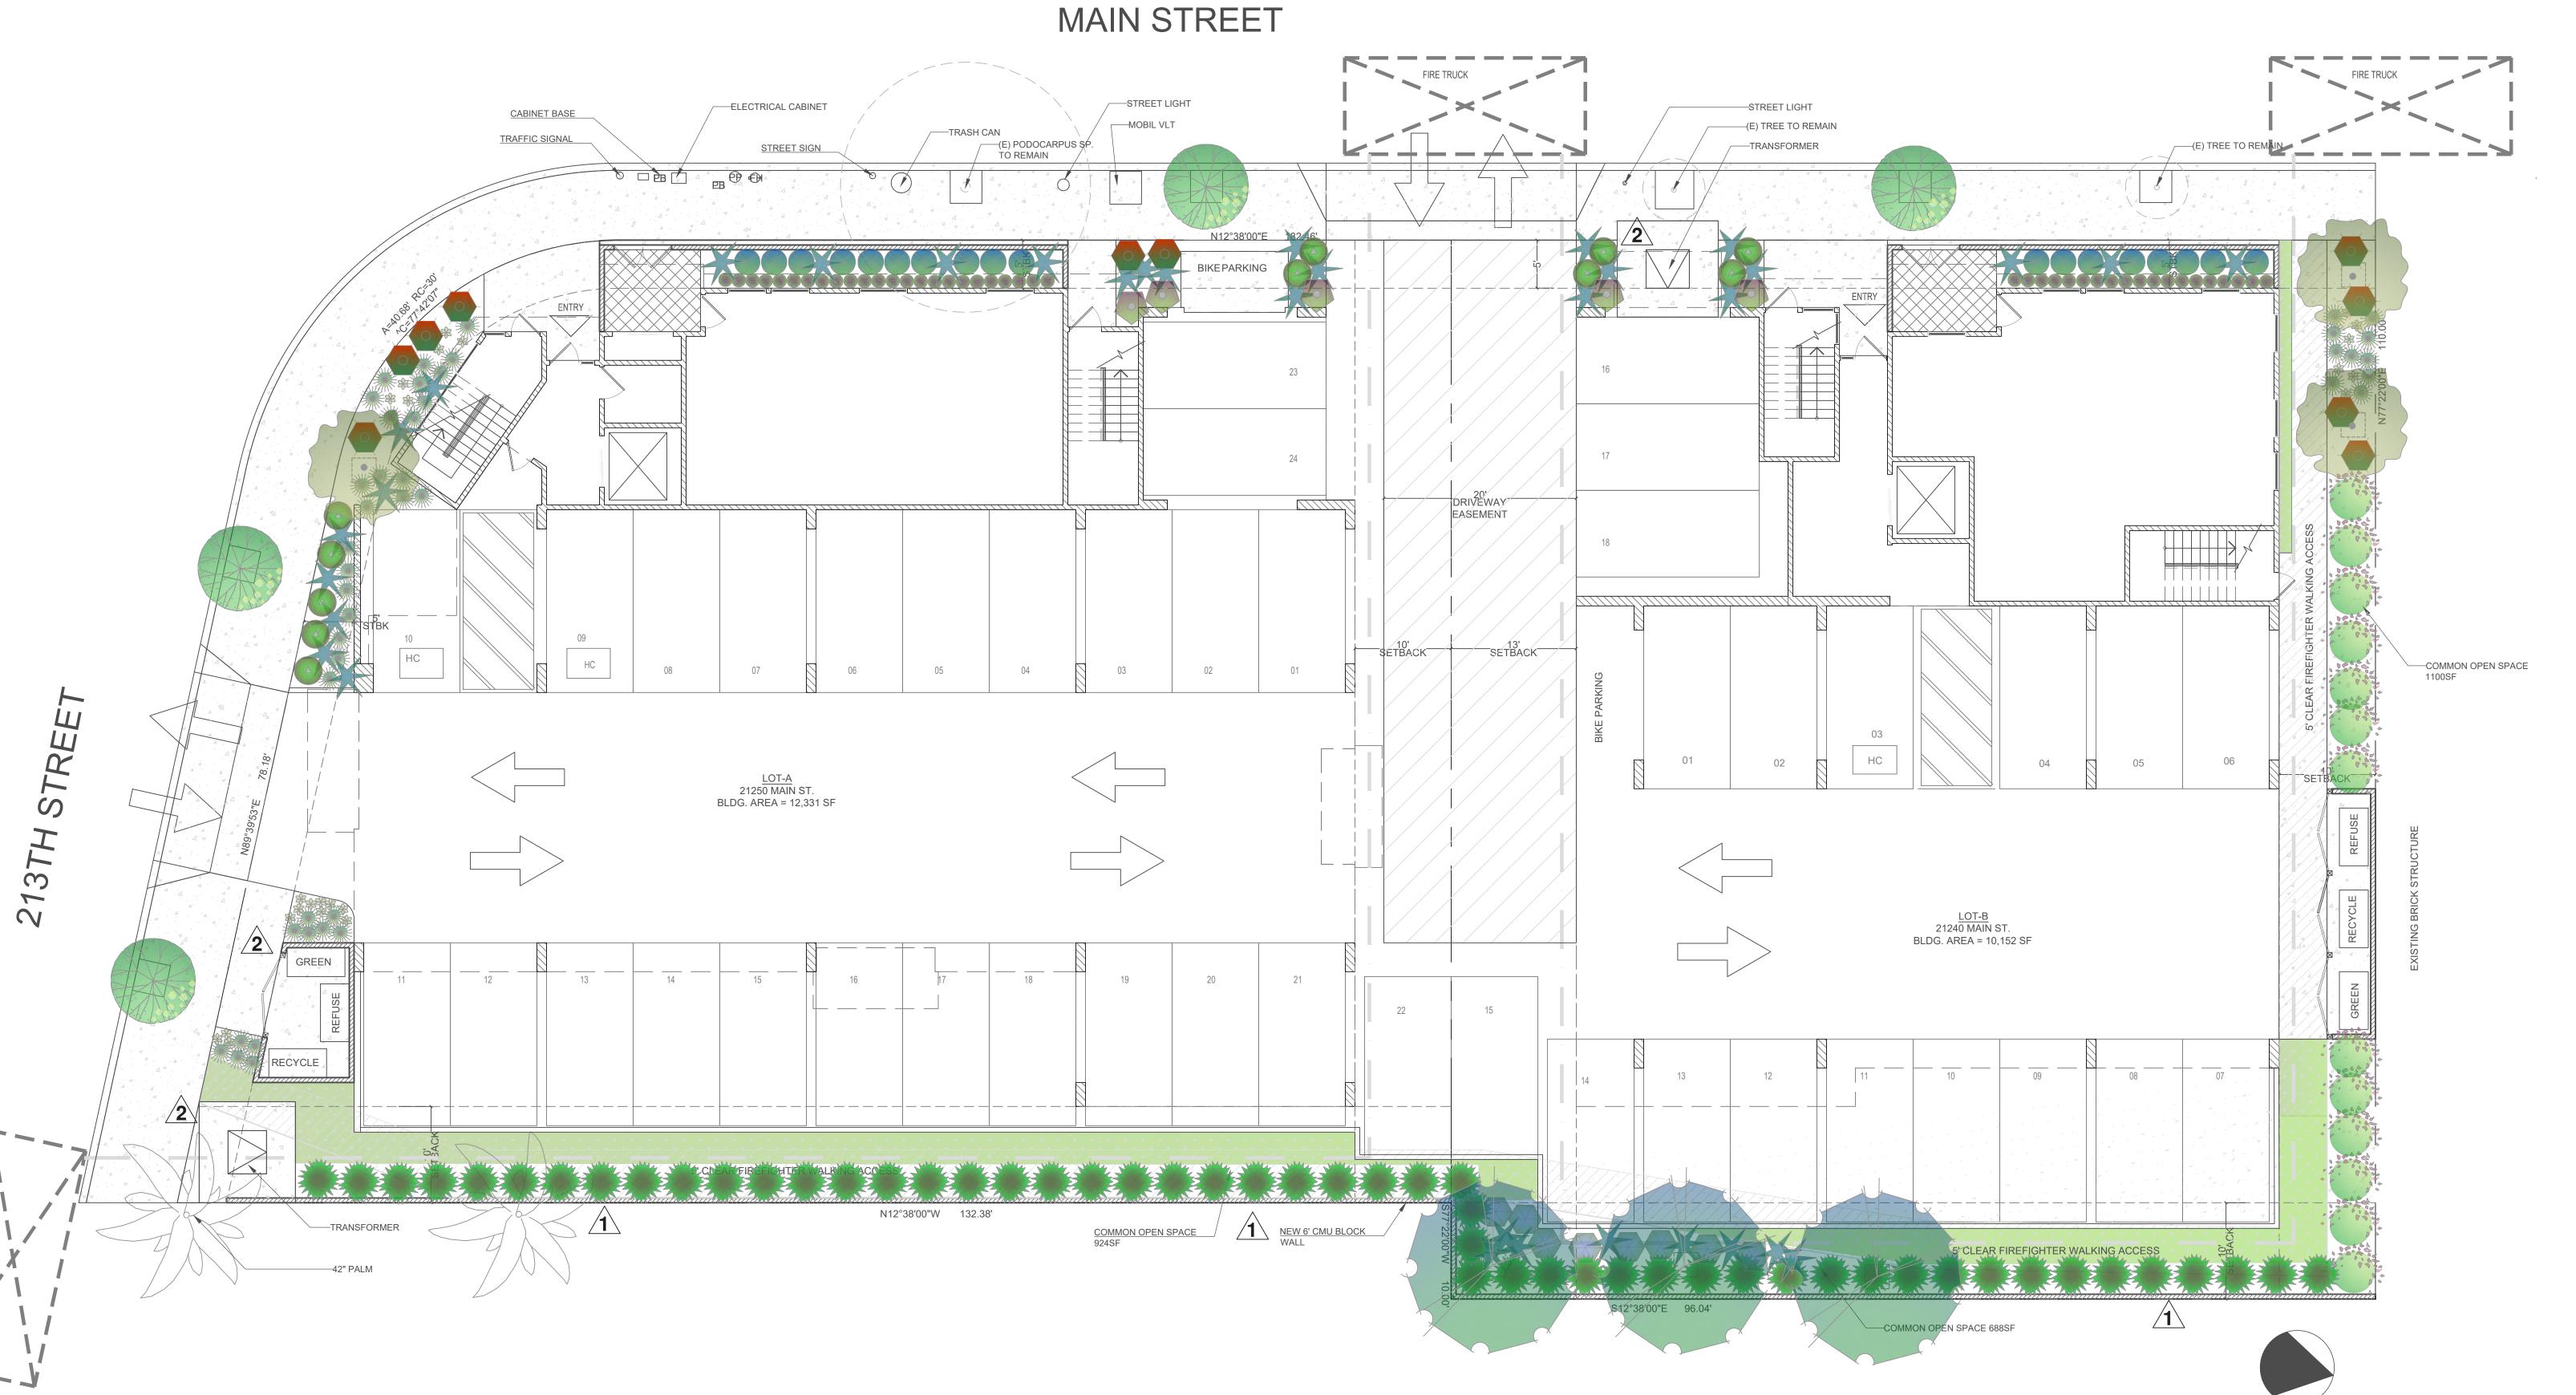

CONCEPTUAL LANDSCAPE PLAN - GROUND FLOOR SCALE: 1/8" = 1'-0"

CARSON LOFTS APARTMENTS 21240 MAIN STREET & 21250 MAIN STREET CARSON, CA 90745

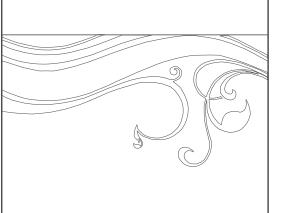


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REVISIONS
AUGUST 13, 202

AUGUST 13, 2021

OCTOBER 15, 2021

DATE:

MAY 27, 2021

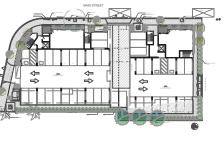SCALE:

1/8" = 1'-0"

CONCEPTUAL PLAN GROUND FLOOR


L.1.0

PLANT LEGEND

	BOTANICAL NAME	COMMON NAME	SIZE AT 5 YRS.	PLANT TYPE	WUCOLS RATING
	ECHEVERIA 'VIOLET QUEEN'	VIOLET QUEEN 'HENS AND CHICKS'	6" X 6"	SUCCULENT	0.3/L
	ECHEVERIA 'ZORRO'	ZORRO ECHEVERIA	18" X 1'	SUCCULENT	0.3/L
	HARDENBERGIA VIOLACEA TRELLISED	PURPLE VINE LILAC	6' X 3'	VINE	0.3/L
	KALANCHOE 'OAK LEAF'	DWARF VELVET PLANT	2' X 2'	SUCCULENT	0.3/L
*	PORTULACARIA AFRA MINIMA	ELEPHANT'S FOOD	>1' X 3'	SUCCULENT	0.3/L
	RUSELLIA EQUISETIFORMIS	CORAL FOUNTAIN	3' X 3'	PERENNIAL	0.3/L
	TRADESCANTIA 'GREENLEE'	PALE PUMA SPIDERWORT	<1' X 4'	SUCCULENT	0.3/L
	XEROSICYOS DANGUYI	SILVER DOLLAR VINE	<1' X 4'	SUCCULENT	0.3/L



CARSON LOFTS APARTMENTS 21240 MAIN STREET & 21250 MAIN STREET CARSON, CA 90745

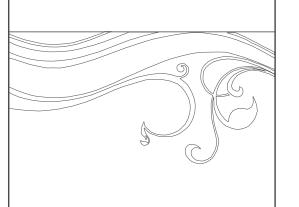


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REVISIONS

DATE:

MAY 27, 2021 SCALE:

1/8" = 1'-0"


CONCEPTUAL PLAN SECOND FLOOR

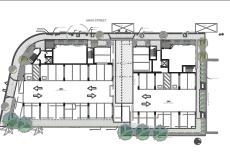_.1.1

CONCEPTUAL LANDSCAPE PLAN -SECOND FLOOR SCALE: 1/8" = 1'-0"

GEIJERA PARVIFLORA AUSTRALIAN WILLOW

XEROSICYOS DANGUYI SILVER DOLLAR VINE ARBUTUS UNEDO STD. STRAWBERRY TREE CARSON LOFTS APARTMENTS 21240 MAIN STREET & 21250 MAIN STREET CARSON, CA 90745

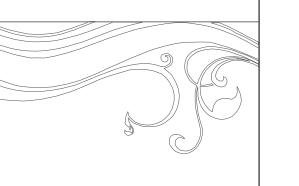

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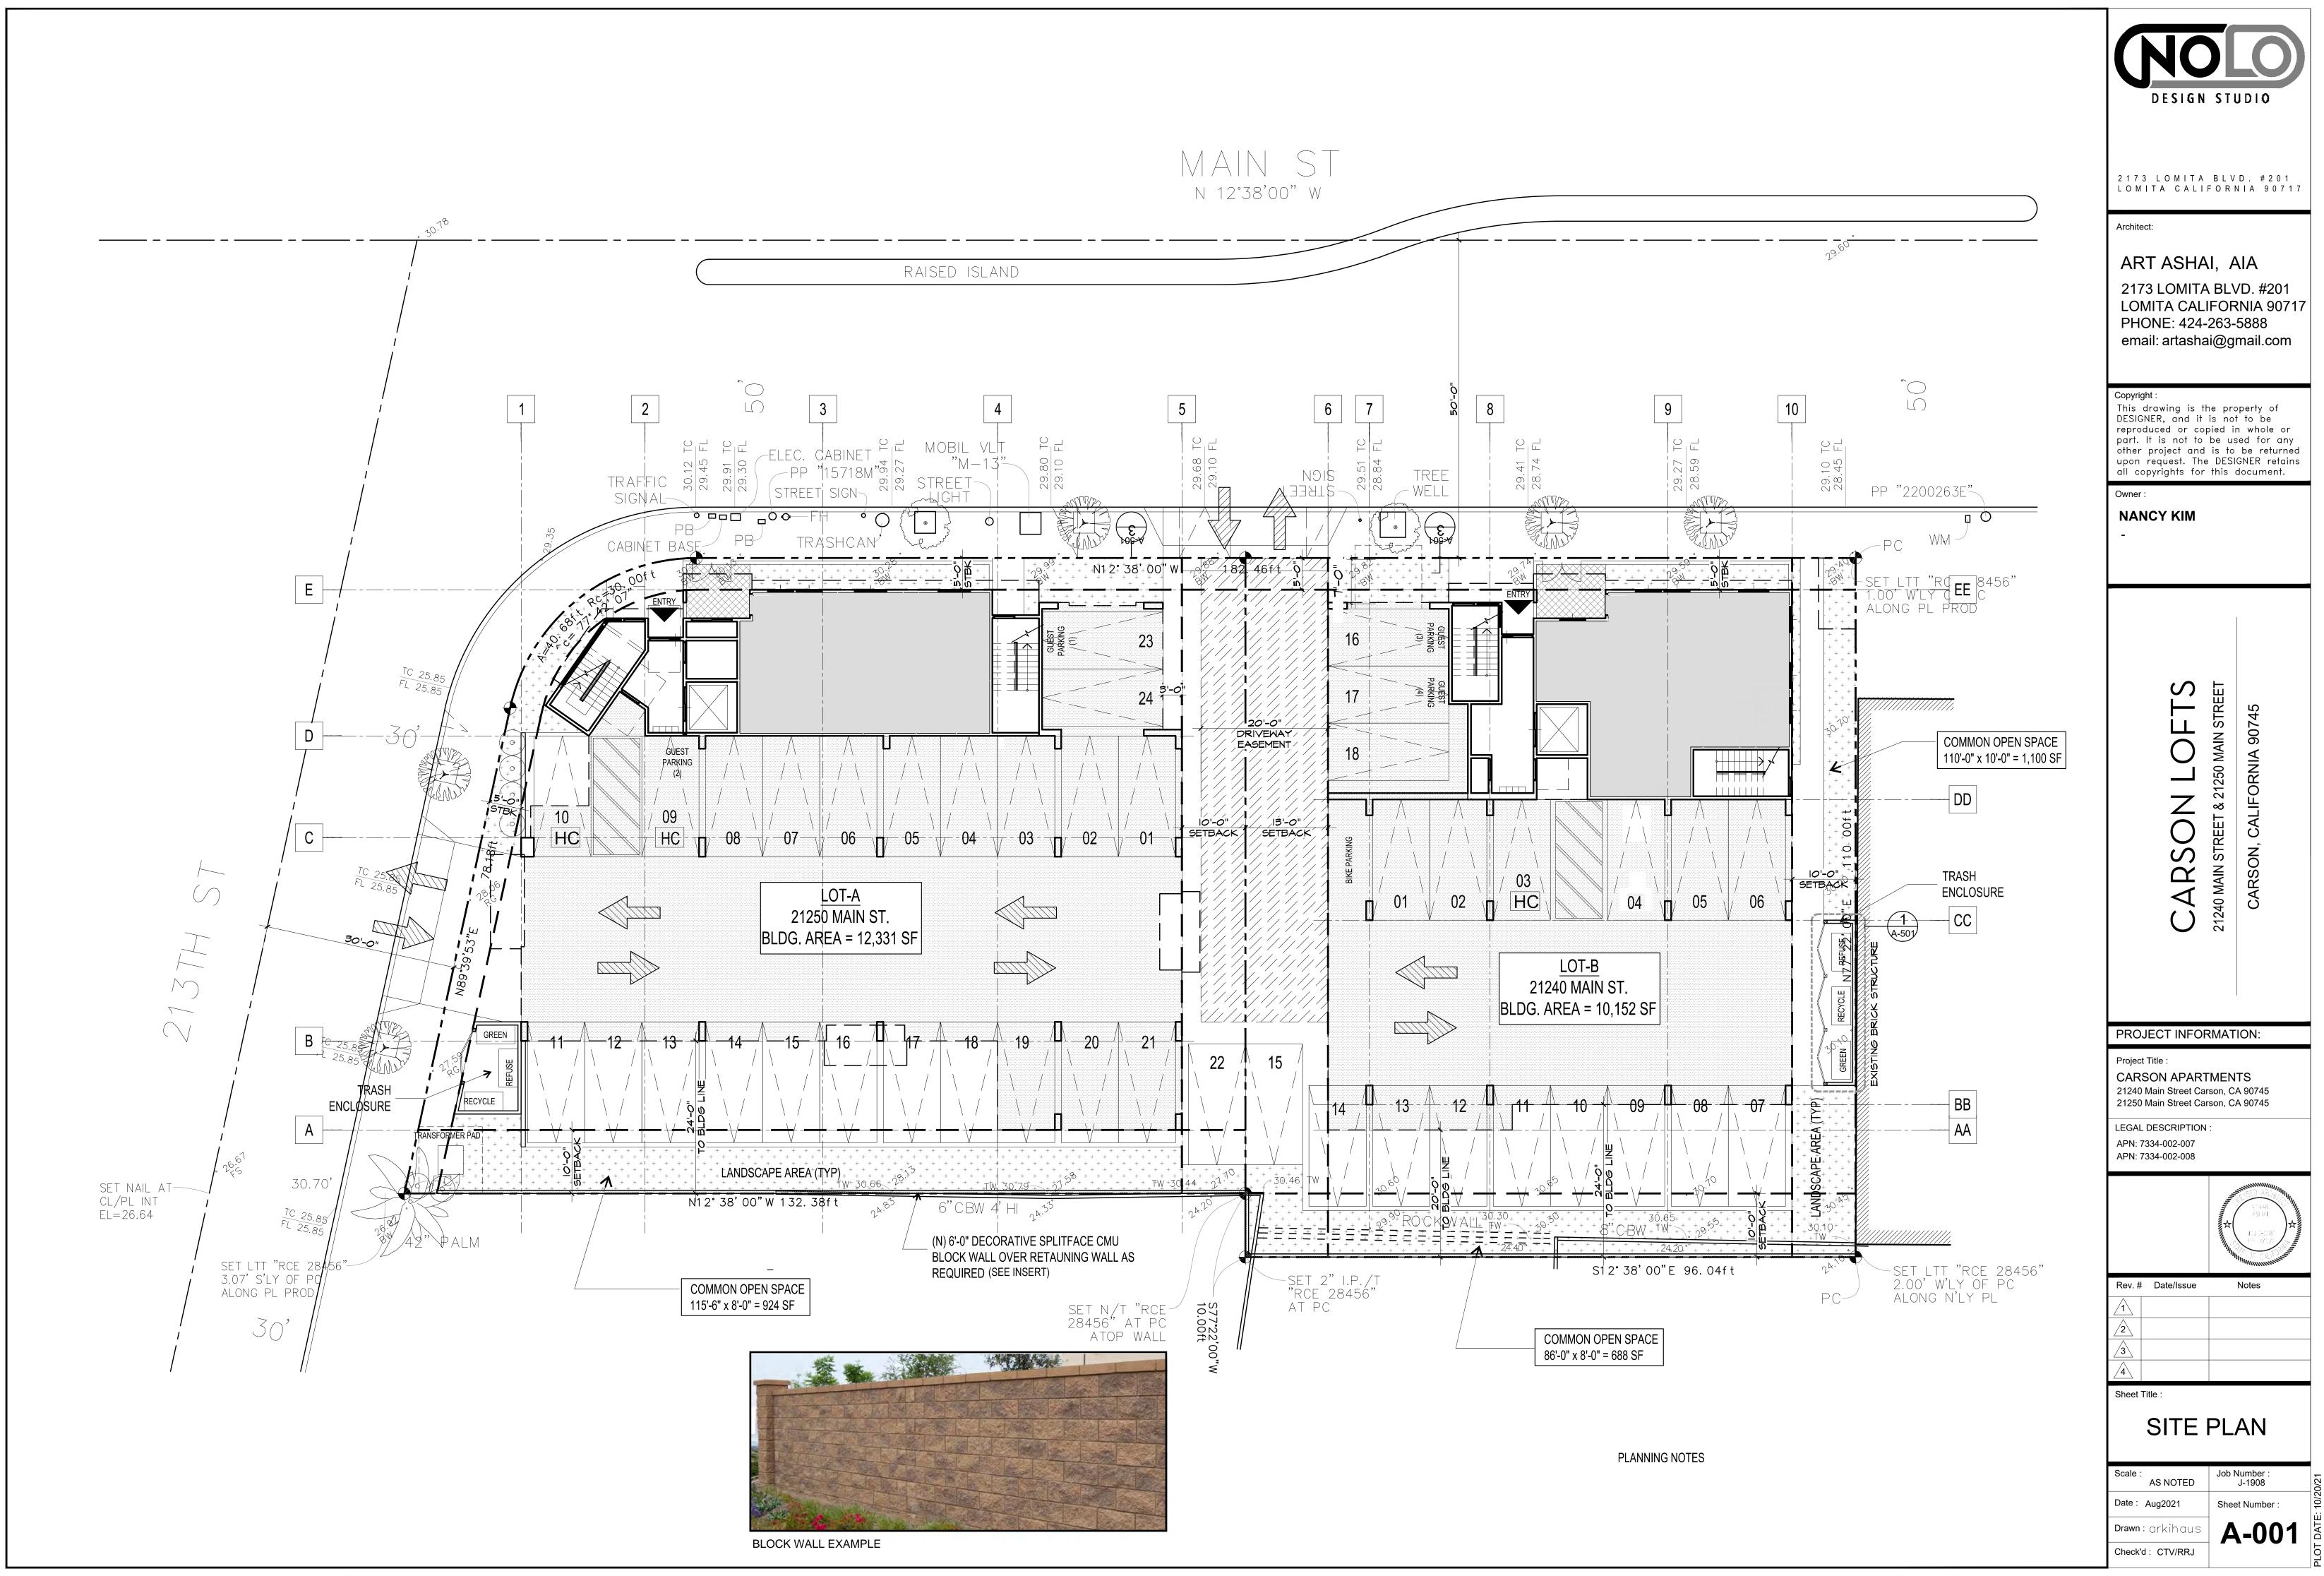
MAY 27, 2021

SCALE:

N.T.S.


PLANT PALETTE

1 2







UNIT WIDTH DEPTH AREA UNIT WIDTH DEPTH AREA 101 10'-0" 9'-0" 90 S.F. 101 10'-10" 9'-0" 98 S.F. 201 10'-6" 7'-0" 74 S.F. 201 11'-6" 7'-0" 81 S.F. 202 11'-2" 6'-4" 71 S.F. 202 10'-6" 7'-0" 74 S.F. 203 12'-0" 6'-4" 76 S.F. 203 12'-0" 4'-6" 54 S.F. 204 12'-4" 6'-4" 78 S.F. 204 11'-2" 6'-4" 71 S.F. 205 14'-10" 6'-4" 94 S.F. 301 11'-6" 7'-0" 81 S.F. 301 10'-10" 7'-0" 76 S.F. 302 9'-10" 7'-0" 69 S.F. 302 11'-2" 6'-4" 71 S.F. 303 12'-0" 4'-6" 54 S.F. 303 12'-0" 6'-4" 76 S.F. 303 11'-2" 6'-4" 71 S.F. </th <th>242501</th> <th>AAINI CEDEET</th> <th>(LOTA) OB</th> <th>N CDACE</th> <th>242404</th> <th>ALL CTREET</th> <th>LOTEN OR</th> <th>ENLODACE</th>	242501	AAINI CEDEET	(LOTA) OB	N CDACE	242404	ALL CTREET	LOTEN OR	ENLODACE
UNIT WIDTH DEPTH AREA 101 10'-0" 9'-0" 90 S.F. 101 10'-10" 9'-0" 98 S.F. 201 10'-6" 7'-0" 74 S.F. 201 11'-6" 7'-0" 81 S.F. 202 11'-2" 6'-4" 71 S.F. 202 10'-6" 7'-0" 74 S.F. 203 12'-0" 6'-4" 76 S.F. 203 12'-0" 4'-6" 54 S.F. 204 12'-4" 6'-4" 78 S.F. 204 11'-2" 6'-4" 71 S.F. 205 14'-10" 6'-4" 94 S.F. 301 11'-6" 7'-0" 81 S.F. 301 10'-10" 7'-0" 76 S.F. 302 9'-10" 7'-0" 69 S.F. 302 11'-2" 6'-4" 71 S.F. 303 12'-0" 4'-6" 54 S.F. 303 12'-0" 6'-4" 77 S.F. 302 9'-10" 7'-0" 69 S.F. 304 12'-4" 6'-4" 78 S.F. 303 12'-0" 4'-6" 54 S.F. 305 14'-2" 6'-4" 78 S.F. 303 12'-0" 4'-6" 54 S.F. 306 12'-4" 6'-4" 78 S.F. 303 12'-0" 4'-6" 54 S.F. 307 12'-0" 6'-4" 78 S.F. 303 12'-0" 4'-6" 54 S.F. 308 12'-0" 6'-4" 78 S.F. TOTAL PRIVATE OPEN SPACE 653 S.F. 309 12'-2" 6'-4" 90 S.F. USEABLE 42'-6" 21'-0" 893 S.F. 300 12'-2" 6'-4" 90 S.F. USEABLE 42'-6" 21'-0" 893 S.F. 301 10'-10" 792 S.F. TOTAL 2,590 S.F. TOTAL 2,590 S.F. TOTAL 2,590 S.F. 302 11'-2" 6'-4" 90 S.F. USEABLE 42'-6" 21'-0" 893 S.F. 303 12'-0" 893 S.F. TOTAL 2,590 S.F. USEABLE 4,500 PRIVATE 98 S.F. COMMON 1,788 S.F. 21250 MAIN STREET - LOT A 21240 MAIN STREET - LOT B SUMMARY OF OPEN SPACES	21250 IV			EN SPACE	21240 MAIN STREET (LOT B) - OPEN SPACE			
101	LINUT			ADEA	LINIT			ADEA
201 10'-6" 7'-0" 74 S.F. 201 11'-6" 7'-0" 81 S.F. 202 11'-2" 6'-4" 71 S.F. 202 10'-6" 7'-0" 74 S.F. 203 12'-0" 6'-4" 76 S.F. 203 12'-0" 4'-6" 54 S.F. 204 12'-4" 6'-4" 78 S.F. 204 11'-2" 6'-4" 71 S.F. 205 14'-10" 6'-4" 94 S.F. 301 11'-6" 7'-0" 81 S.F. 301 10'-10" 7'-0" 76 S.F. 302 9'-10" 7'-0" 69 S.F. 302 11'-2" 6'-4" 71 S.F. 303 12'-0" 4'-6" 54 S.F. 304 12'-4" 6'-4" 78 S.F. TOTAL PRIVATE OPEN SPACE 653 S.F. 305 14'-2" 6'-4" 79 S.F. USEABLE 42'-6" 21'-0" 893 S.F. TOTAL PRIVATE OPEN SPACE 53 S.F. 305 14'-2" 6'-4" 792 S.F. 305 14'-2" 6'-4" 792 S.F. 305 34 S.F. 305 35 S.F. 305 3			 					
202								+
203			+					-
204								
205			+					
301 10'-10" 7'-0" 76 S.F. 302 9'-10" 7'-0" 69 S.F. 302 11'-2" 6'-4" 71 S.F. 303 12'-0" 4'-6" 54 S.F. 303 12'-0" 6'-4" 76 S.F. 303 11'-2" 6'-4" 71 S.F. 304 12'-4" 6'-4" 78 S.F. TOTAL PRIVATE OPEN SPACE 653 S.f. 305 14'-2" 6'-4" 90 S.F. USEABLE 42'-6" 21'-0" 893 S.F. TOTAL PRIVATE OPEN SPACE 874 S.F. COMMON 1,788 S.F. TOTAL PRIVATE OPEN SPACE 874 S.F. COMMON 1,788 S.F. TOTAL 2,590 S.F. TOTAL 3,334 S.F. TOTAL 2,590 S.F. TOTAL 3,334 S.F. TOTAL 2,590 S.F. TOTAL 3,334 S.F. TOTAL 3,334 S.F. TOTAL 15T PRIVATE 98 S.F. COMMON 924 S.F. COMMON 1,788 S.F. TOMMON 924 S.F. COMMON 1,788 S.F. COMMON 924 S.F. COMMON 1,788 S.F. TOTAL 15T PRIVATE 90 S.F. 15T PRIVATE 98 S.F. COMMON 924 S.F. COMMON 1,788 S.F. COMMON 924 S.F. COMMON 1,788 S.F. TOTAL 15T PRIVATE 98 S.F. COMMON 1,788 S.F. COMMON 924 S.F. COMMON 1,788 S.F. COMMON 924 S.F. USEABLE 893 S.F. USEABLE 792 S.F. USEABLE 893 S.F. TOTAL 2 ^{MD} PRIVATE 280 S.F. TOTAL 2 ^{MD} PRIVATE 275 S.F. 380 PRIVATE 391 S.F. 380 PRIVATE 275 S.F. TOTAL 3 RD PRIVATE 275 S.F. TOTAL 3 RD PRIVATE 275 S.F.								-
302			<u> </u>	<u> </u>				+
303			+					-
304 12'-4" 6'-4" 78 S.F. TOTAL PRIVATE OPEN SPACE 653 s.f. 305	302	11'-2"		71 S.F.	303	12'-0"	4'-6"	54 S.F.
305	303	12'-0"	6'-4"	76 S.F.	303	11'-2"	6′-4″	71 S.F.
1,788 S.F. 1,7	304	12'-4"	6'-4"	78 S.F.	TOTAL PRIV	ATE OPEN SP	ACE	653 s.f.
SEABLE	305	14'-2"	6'-4"	90 S.F.	USEABLE	42'-6"	21'-0"	893 S.F.
P24 S.F. TOTAL 2,590 S.F. TOTAL 3,334 S.F.	TOTAL PRIV	ATE OPEN SP	N SPACE 874 S.F. COMMON		1,788 S.F.			
TOTAL 2,590 S.F. TOTAL 3,334 S.F. 21250 MAIN STREET − LOT A 21240 MAIN STREET − LOT B SUMMARY OF OPEN SPACES SUMMARY OF OPEN SPACES FLOOR SPACE AREA 1 ST PRIVATE 90 S.F. 1 ST PRIVATE 98 S.F. COMMON 924 S.F. COMMON 1,788 S.F. 2 ND PRIVATE 393 S.F. 2 ND PRIVATE 280 S.F. 2 ND PRIVATE 393 S.F. USEABLE 893 S.F. 3 RD PRIVATE 391 S.F. 3 RD PRIVATE 275 S.F. 3 RD PRIVATE 391 S.F. TOTAL 3 RD FLOOR: 666 S.F.	USEABLE	49'-6"	16′-0″	792 S.F.				
21250 MAIN STREET - LOT A 21240 MAIN STREET - LOT B SUMMARY OF OPEN SPACES SUMMARY OF OPEN SPACES FLOOR	COMMON			924 S.F.				
SUMMARY OF OPEN SPACES FLOOR SPACE AREA FLOOR SPACE AREA 1 ST PRIVATE 90 S.F. 1 ST PRIVATE 98 S.F. COMMON 924 S.F. COMMON 1,788 S.F. 2 ND PRIVATE 393 S.F. 2 ND PRIVATE 280 S.F. USEABLE 792 S.F. USEABLE 893 S.F. 3 RD PRIVATE 275 S.F. 3 RD PRIVATE 275 S.F. TOTAL 3 RD FLOOR: 666 S.F.			TOTAL	2,590 S.F.		3,334 S.F.		
FLOOR SPACE AREA FLOOR SPACE AREA 1ST PRIVATE 90 S.F. 1ST PRIVATE 98 S.F. COMMON 924 S.F. COMMON 1,788 S.F. TOTAL 1ST FLOOR: 2,900 S.F. 2ND PRIVATE 393 S.F. 2ND PRIVATE 280 S.F. USEABLE 792 S.F. USEABLE 893 S.F. 3RD PRIVATE 275 S.F. TOTAL 3RD FLOOR: 666 S.F.								
1ST PRIVATE 90 S.F. 1ST PRIVATE 98 S.F. COMMON 924 S.F. COMMON 1,788 S.F. TOTAL 1ST FLOOR: 2,900 S.F. 2ND PRIVATE 393 S.F. 2ND PRIVATE 280 S.F. USEABLE 792 S.F. USEABLE 893 S.F. TOTAL 2ND FLOOR: 2,358 S.F. 3RD PRIVATE 275 S.F. TOTAL 3RD FLOOR: 666 S.F.		<u> </u>						
COMMON 924 S.F. COMMON 1,788 S.F. TOTAL 1 ST FLOOR: 2,900 S.F. 2 ND PRIVATE 393 S.F. 2 ND PRIVATE 280 S.F. USEABLE 792 S.F. USEABLE 893 S.F. 3 RD PRIVATE 2,358 S.F. 3 RD PRIVATE 275 S.F. TOTAL 3 RD FLOOR: 666 S.F.						georges		
TOTAL 1 ST FLOOR: 2,900 S.F. 2 ND PRIVATE 393 S.F. 2 ND PRIVATE 280 S.F. USEABLE 792 S.F. USEABLE 893 S.F. TOTAL 2 ND FLOOR: 2,358 S.F. 3 RD PRIVATE 275 S.F. TOTAL 3 RD FLOOR: 666 S.F.								
2 ND PRIVATE 393 S.F. 2 ND PRIVATE 280 S.F. USEABLE 792 S.F. USEABLE 893 S.F. TOTAL 2 ND FLOOR: 2,358 S.F. 3 RD PRIVATE 391 S.F. 3 RD PRIVATE 275 S.F. TOTAL 3 RD FLOOR: 666 S.F.	COMMON		924 S.F.	<u> </u>			-	
USEABLE 792 S.F. USEABLE 893 S.F. TOTAL 2 ND FLOOR: 2,358 S.F. 3 RD PRIVATE 391 S.F. 3 RD PRIVATE 275 S.F. TOTAL 3 RD FLOOR: 666 S.F.	N/D				- ND			
TOTAL 2 ND FLOOR: 2,358 S.F. 3RD PRIVATE 391 S.F. 3RD PRIVATE 275 S.F. TOTAL 3 RD FLOOR: 666 S.F.					2110			
3RD PRIVATE 391 S.F. 3RD PRIVATE 275 S.F. TOTAL 3RD FLOOR: 666 S.F.	USEABLE		792 S.F.	<u> </u>				
TOTAL 3 RD FLOOR: 666 S.F.								-
	3 RD	PRI	/ATE	391 S.F.	3 RD			275 S.F.
TOTAL OPEN SPACE PROVIDED: 5,924 S.F.						TOTAL 3 RD	FLOOR:	666 S.F.
					TOTAL OPE	N SPACE PRO	OVIDED:	5,924 S.F.

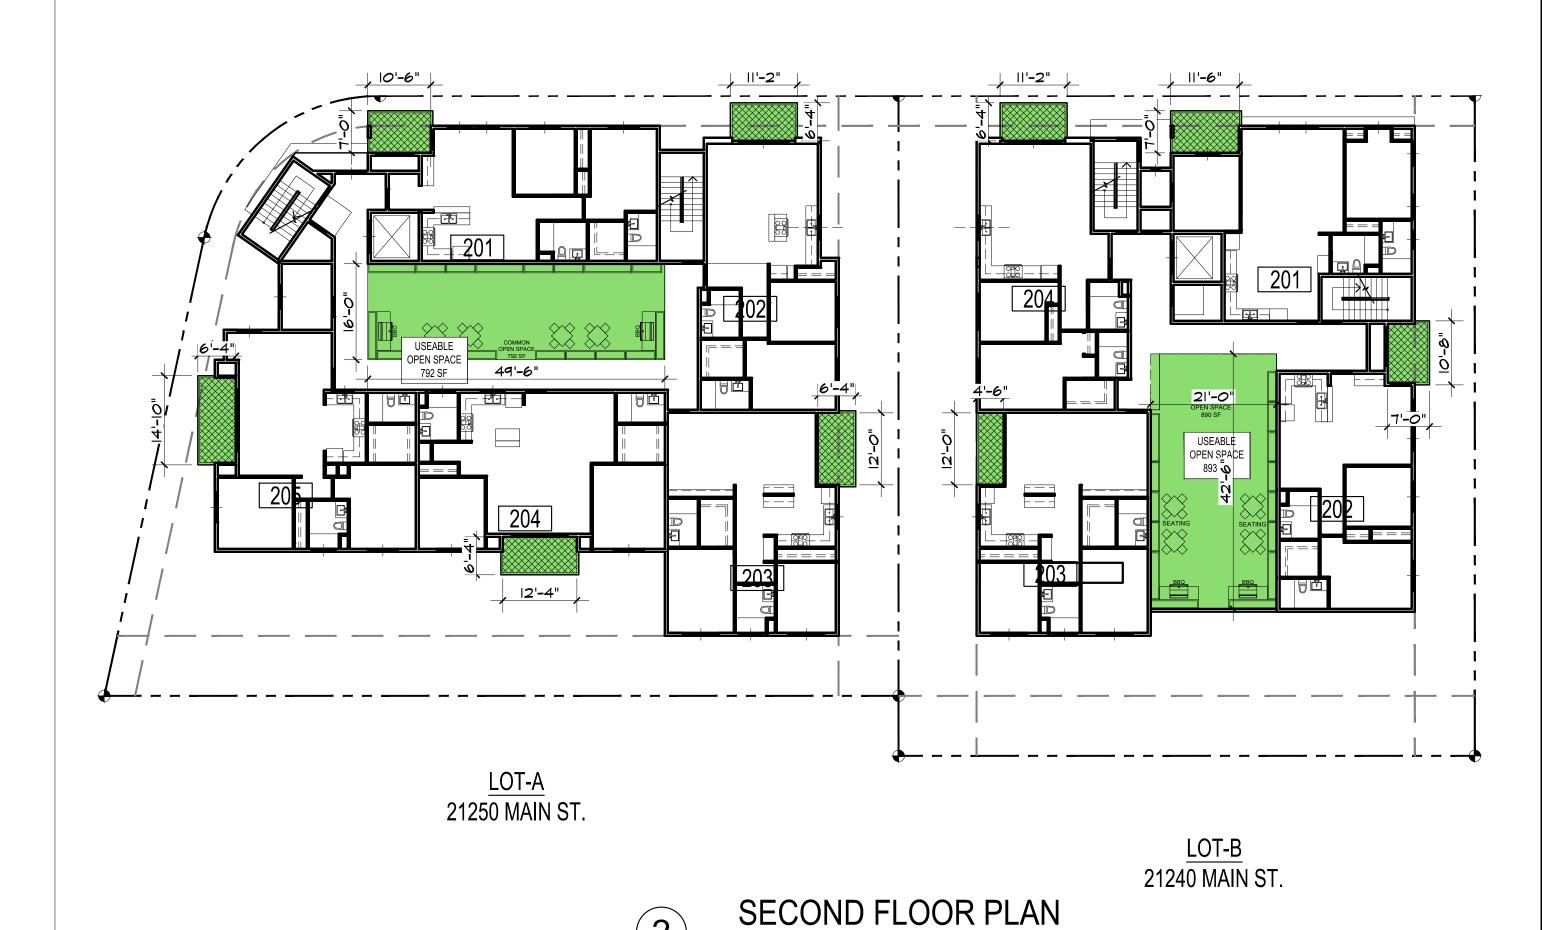

SCALE: 1/16" = 1'-0"

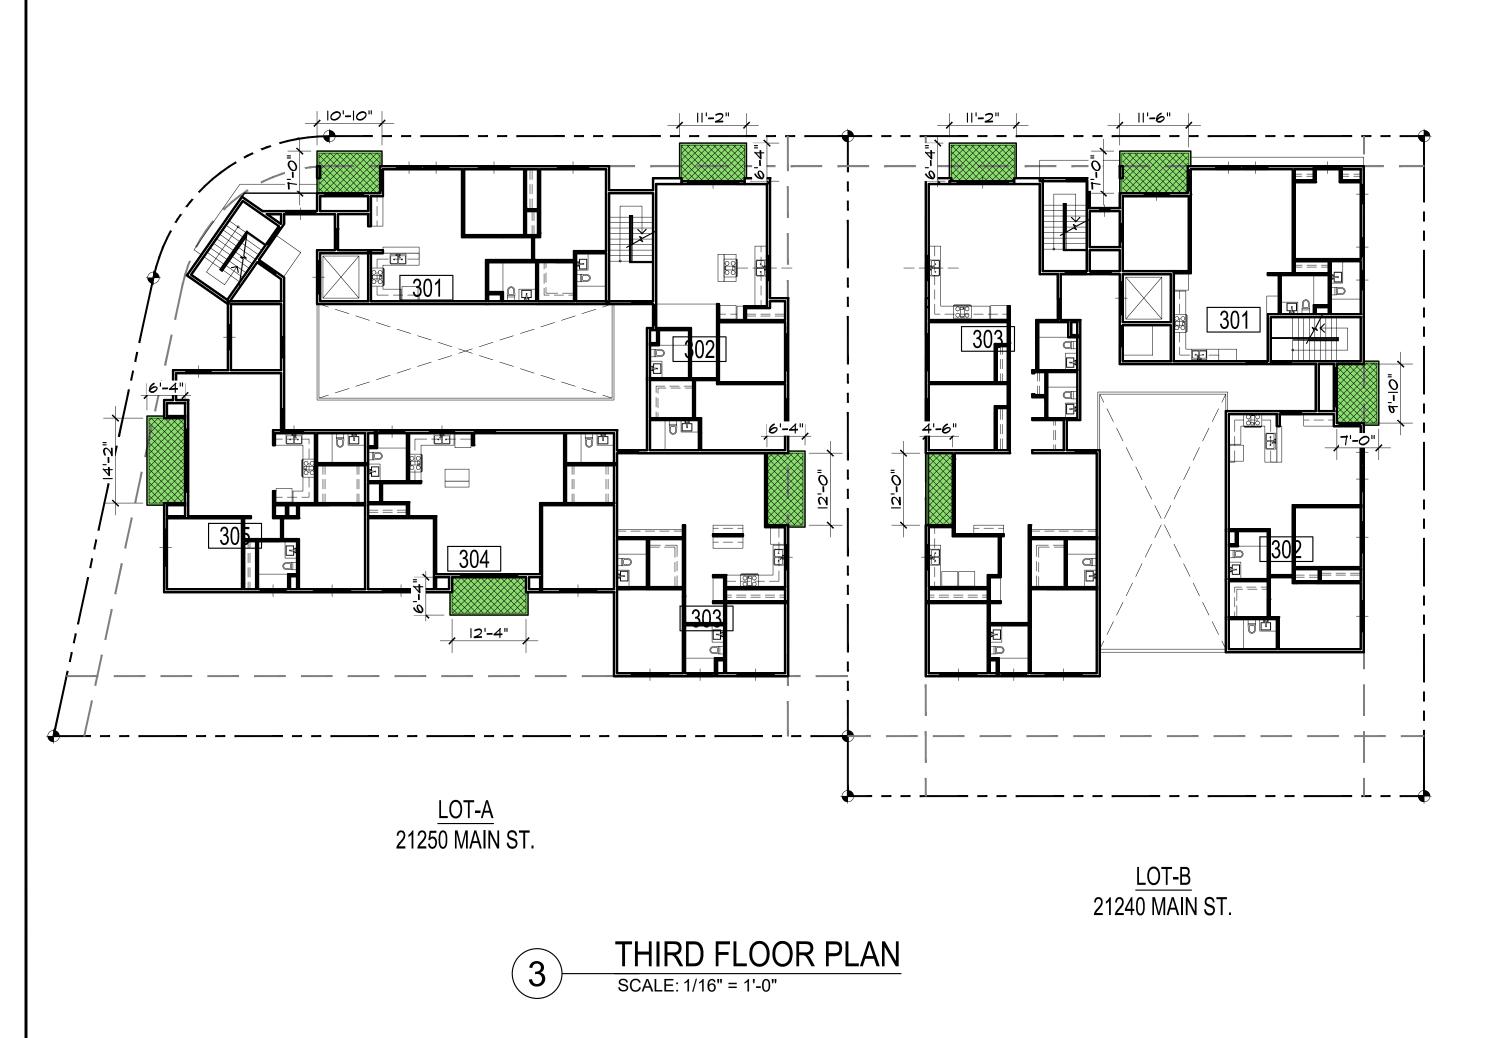

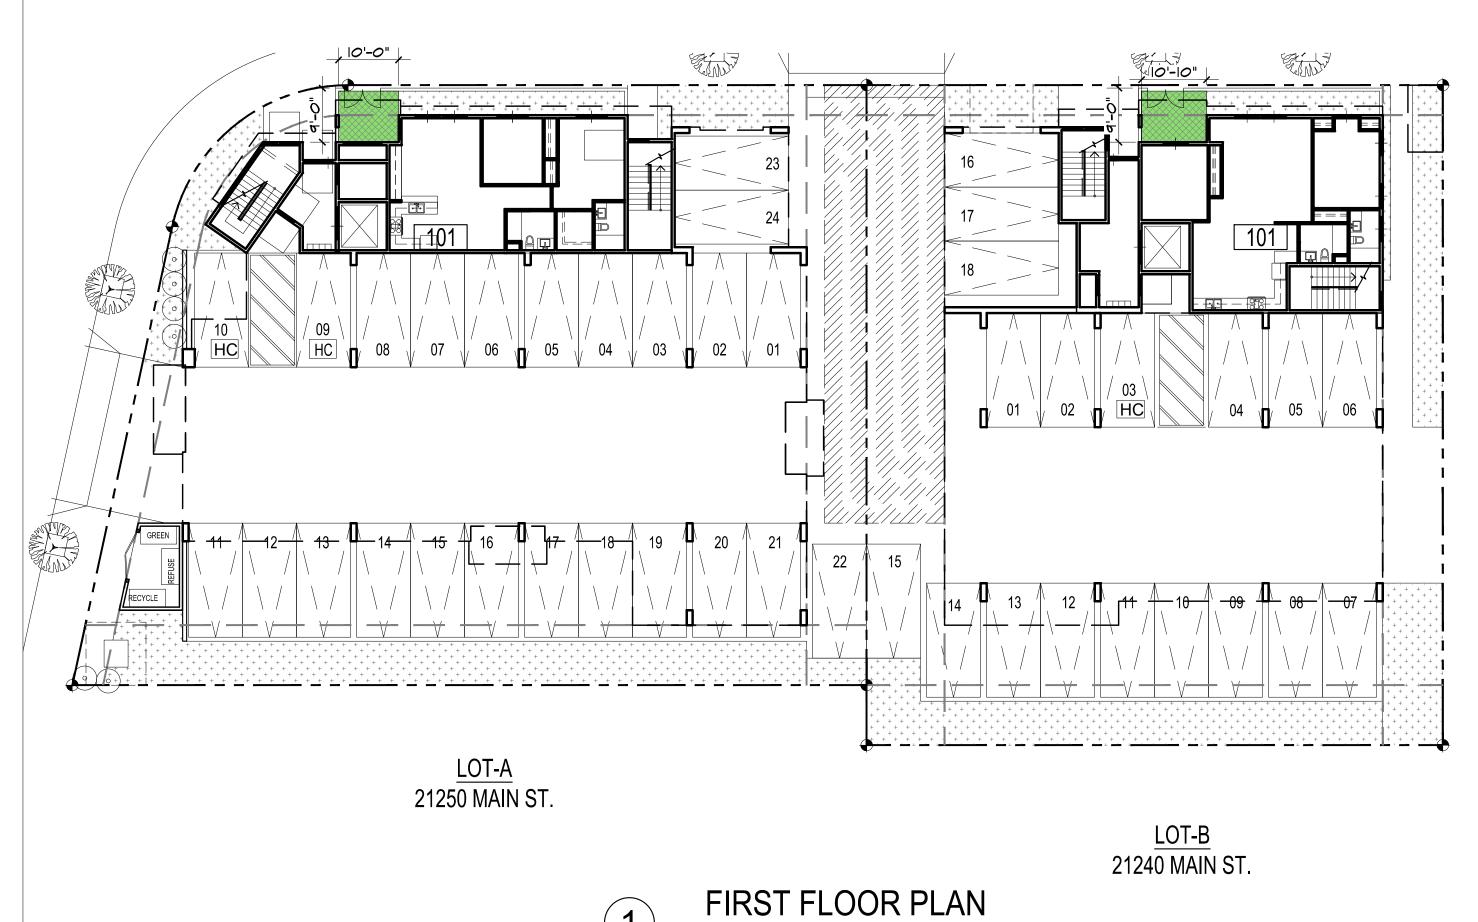

SCALE: 1/16" = 1'-0"

NO LO DESIGN STUDIO

2 1 7 3 L O M I T A B L V D . # 2 0 1 L O M I T A C A L I F O R N I A 9 0 7 1 7

Architect:

ART ASHAI, AIA
2173 LOMITA BLVD. #201
LOMITA CALIFORNIA 90717
PHONE: 424-263-5888
email: artashai@gmail.com

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Owner:

NANCY KIM

CARSON LOFIS
21240 MAIN STREET & 21250 MAIN STREET

PROJECT INFORMATION:


Project Title :

CARSON APARTMENTS

21240 Main Street Carson, CA 90745

21250 Main Street Carson, CA 90745

LEGAL DESCRIPTION APN: 7334-002-007 APN: 7334-002-008

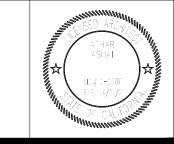



Rev.#	Date/Issue	Notes
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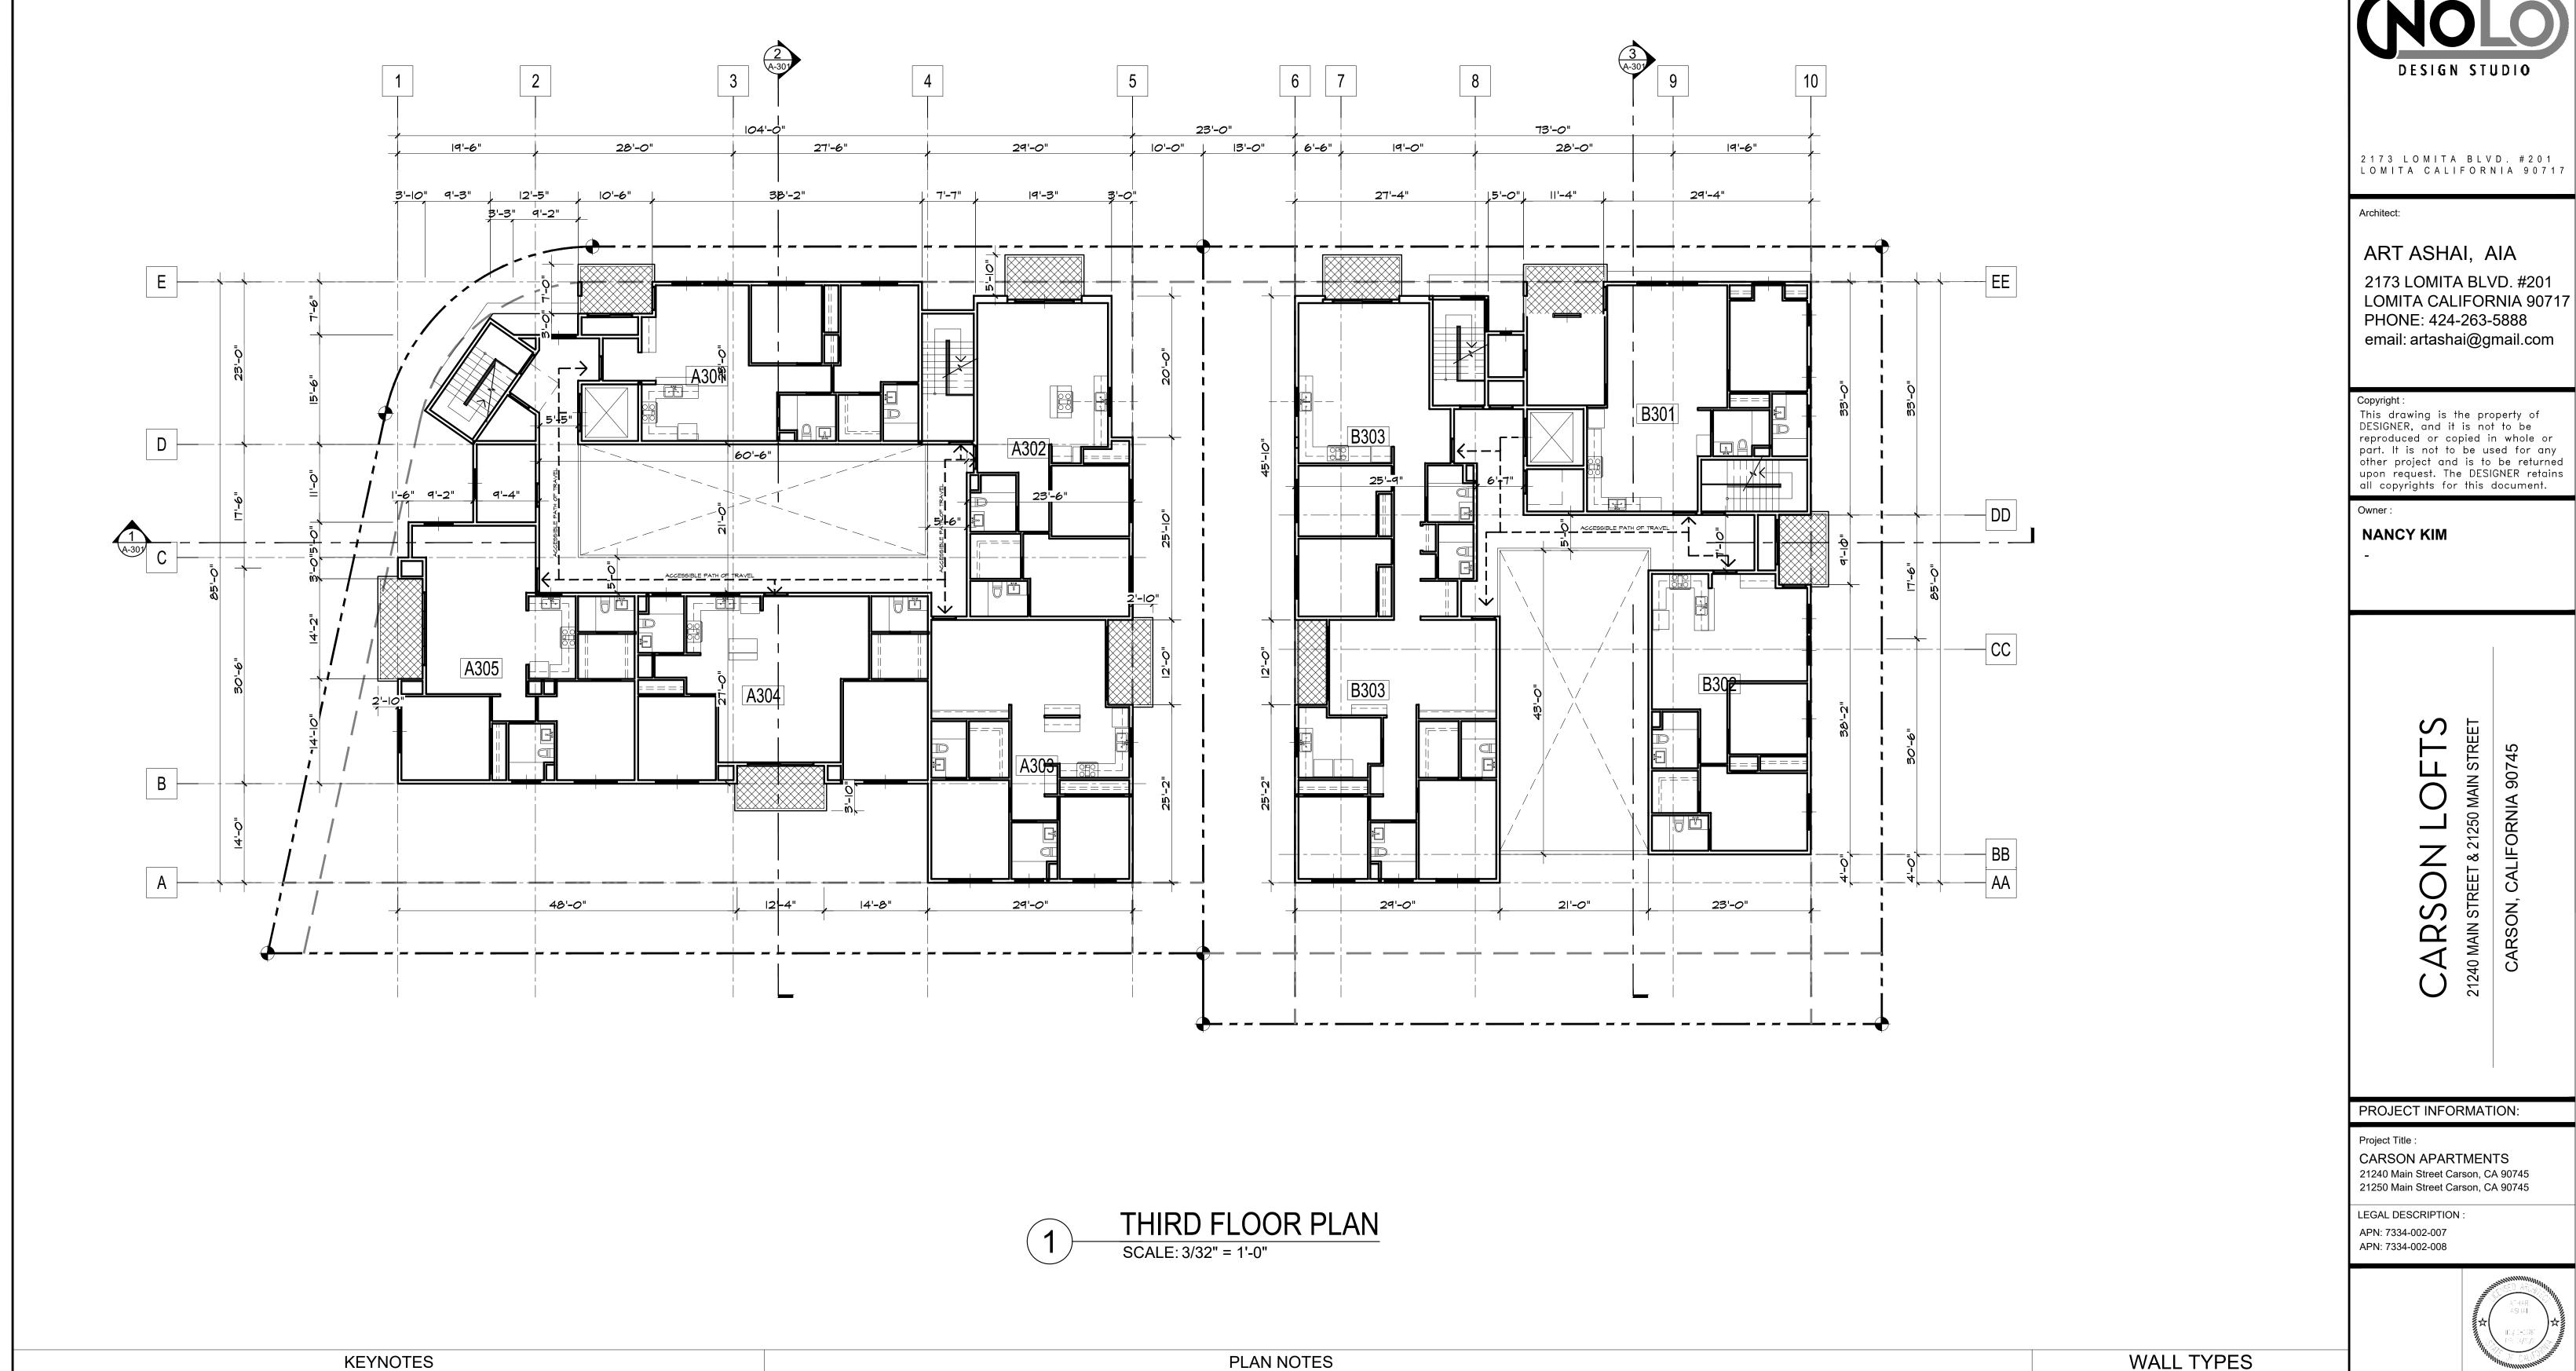
Sheet Title :

OPEN SPACE

Scale : AS NOTED	Job Number : J-1908
Date : Aug2021	Sheet Number :
Drawn: arkihaus	A-003
Check'd: CTV/RRJ	71000



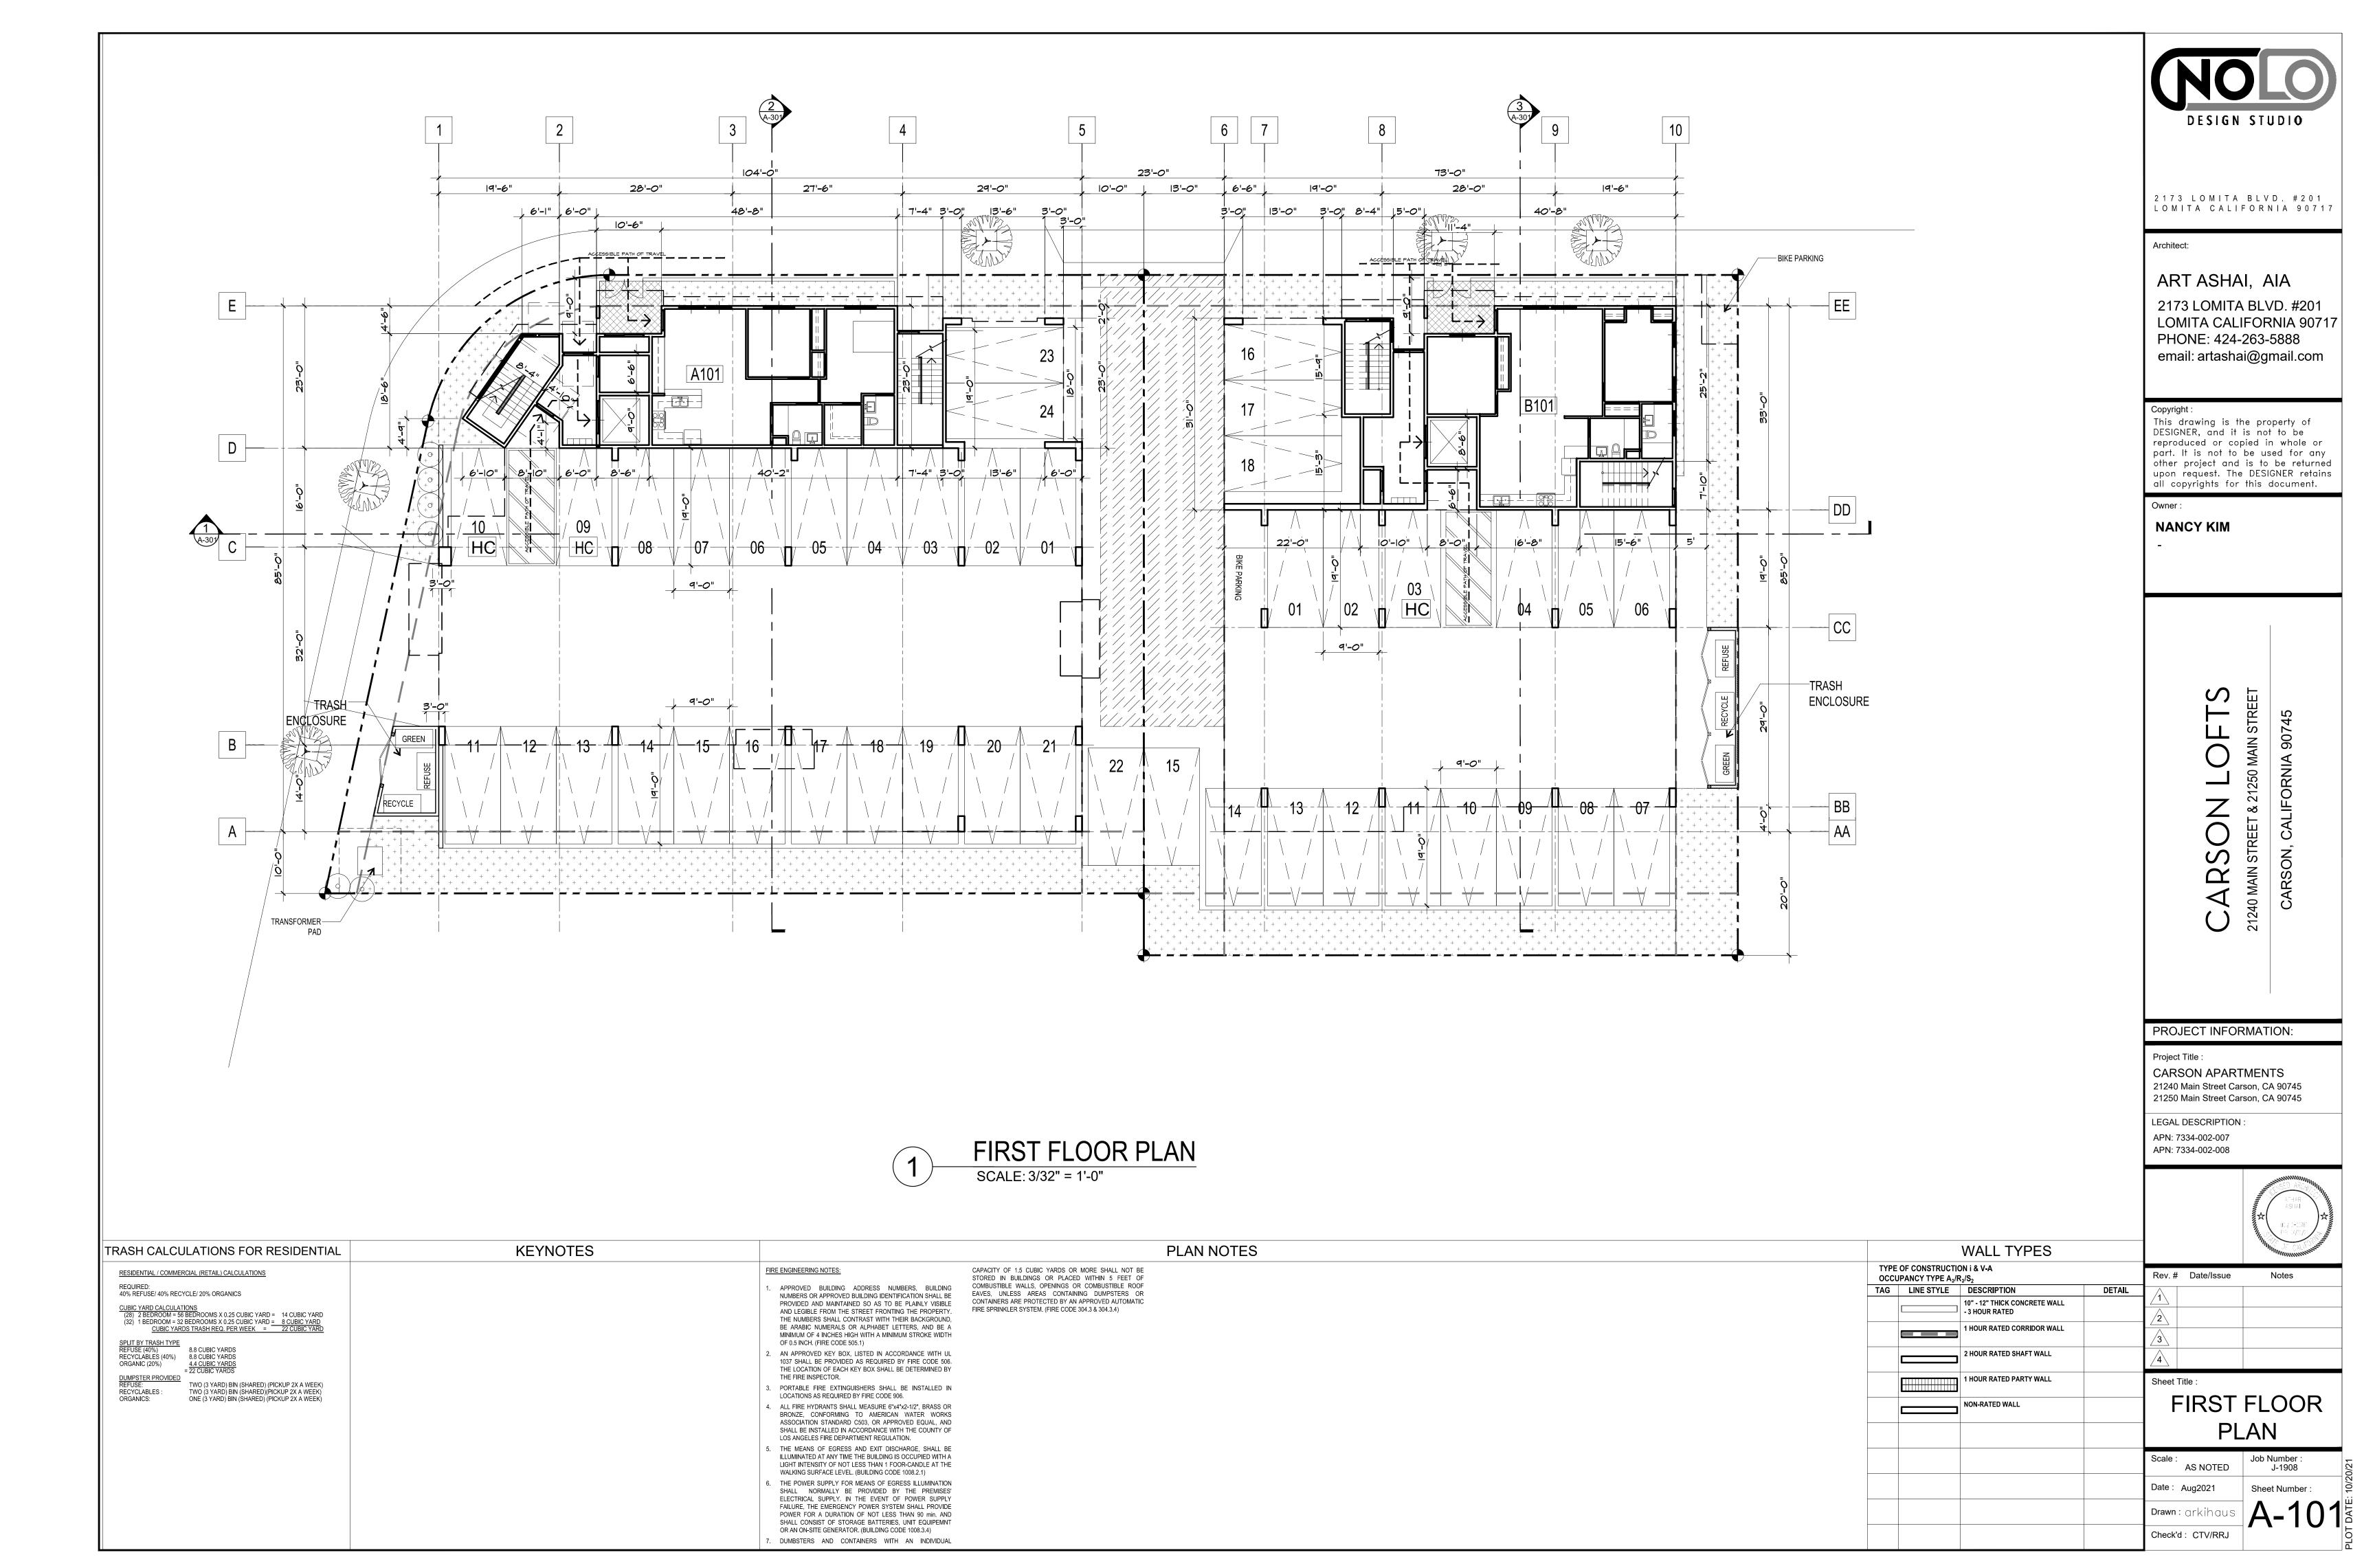

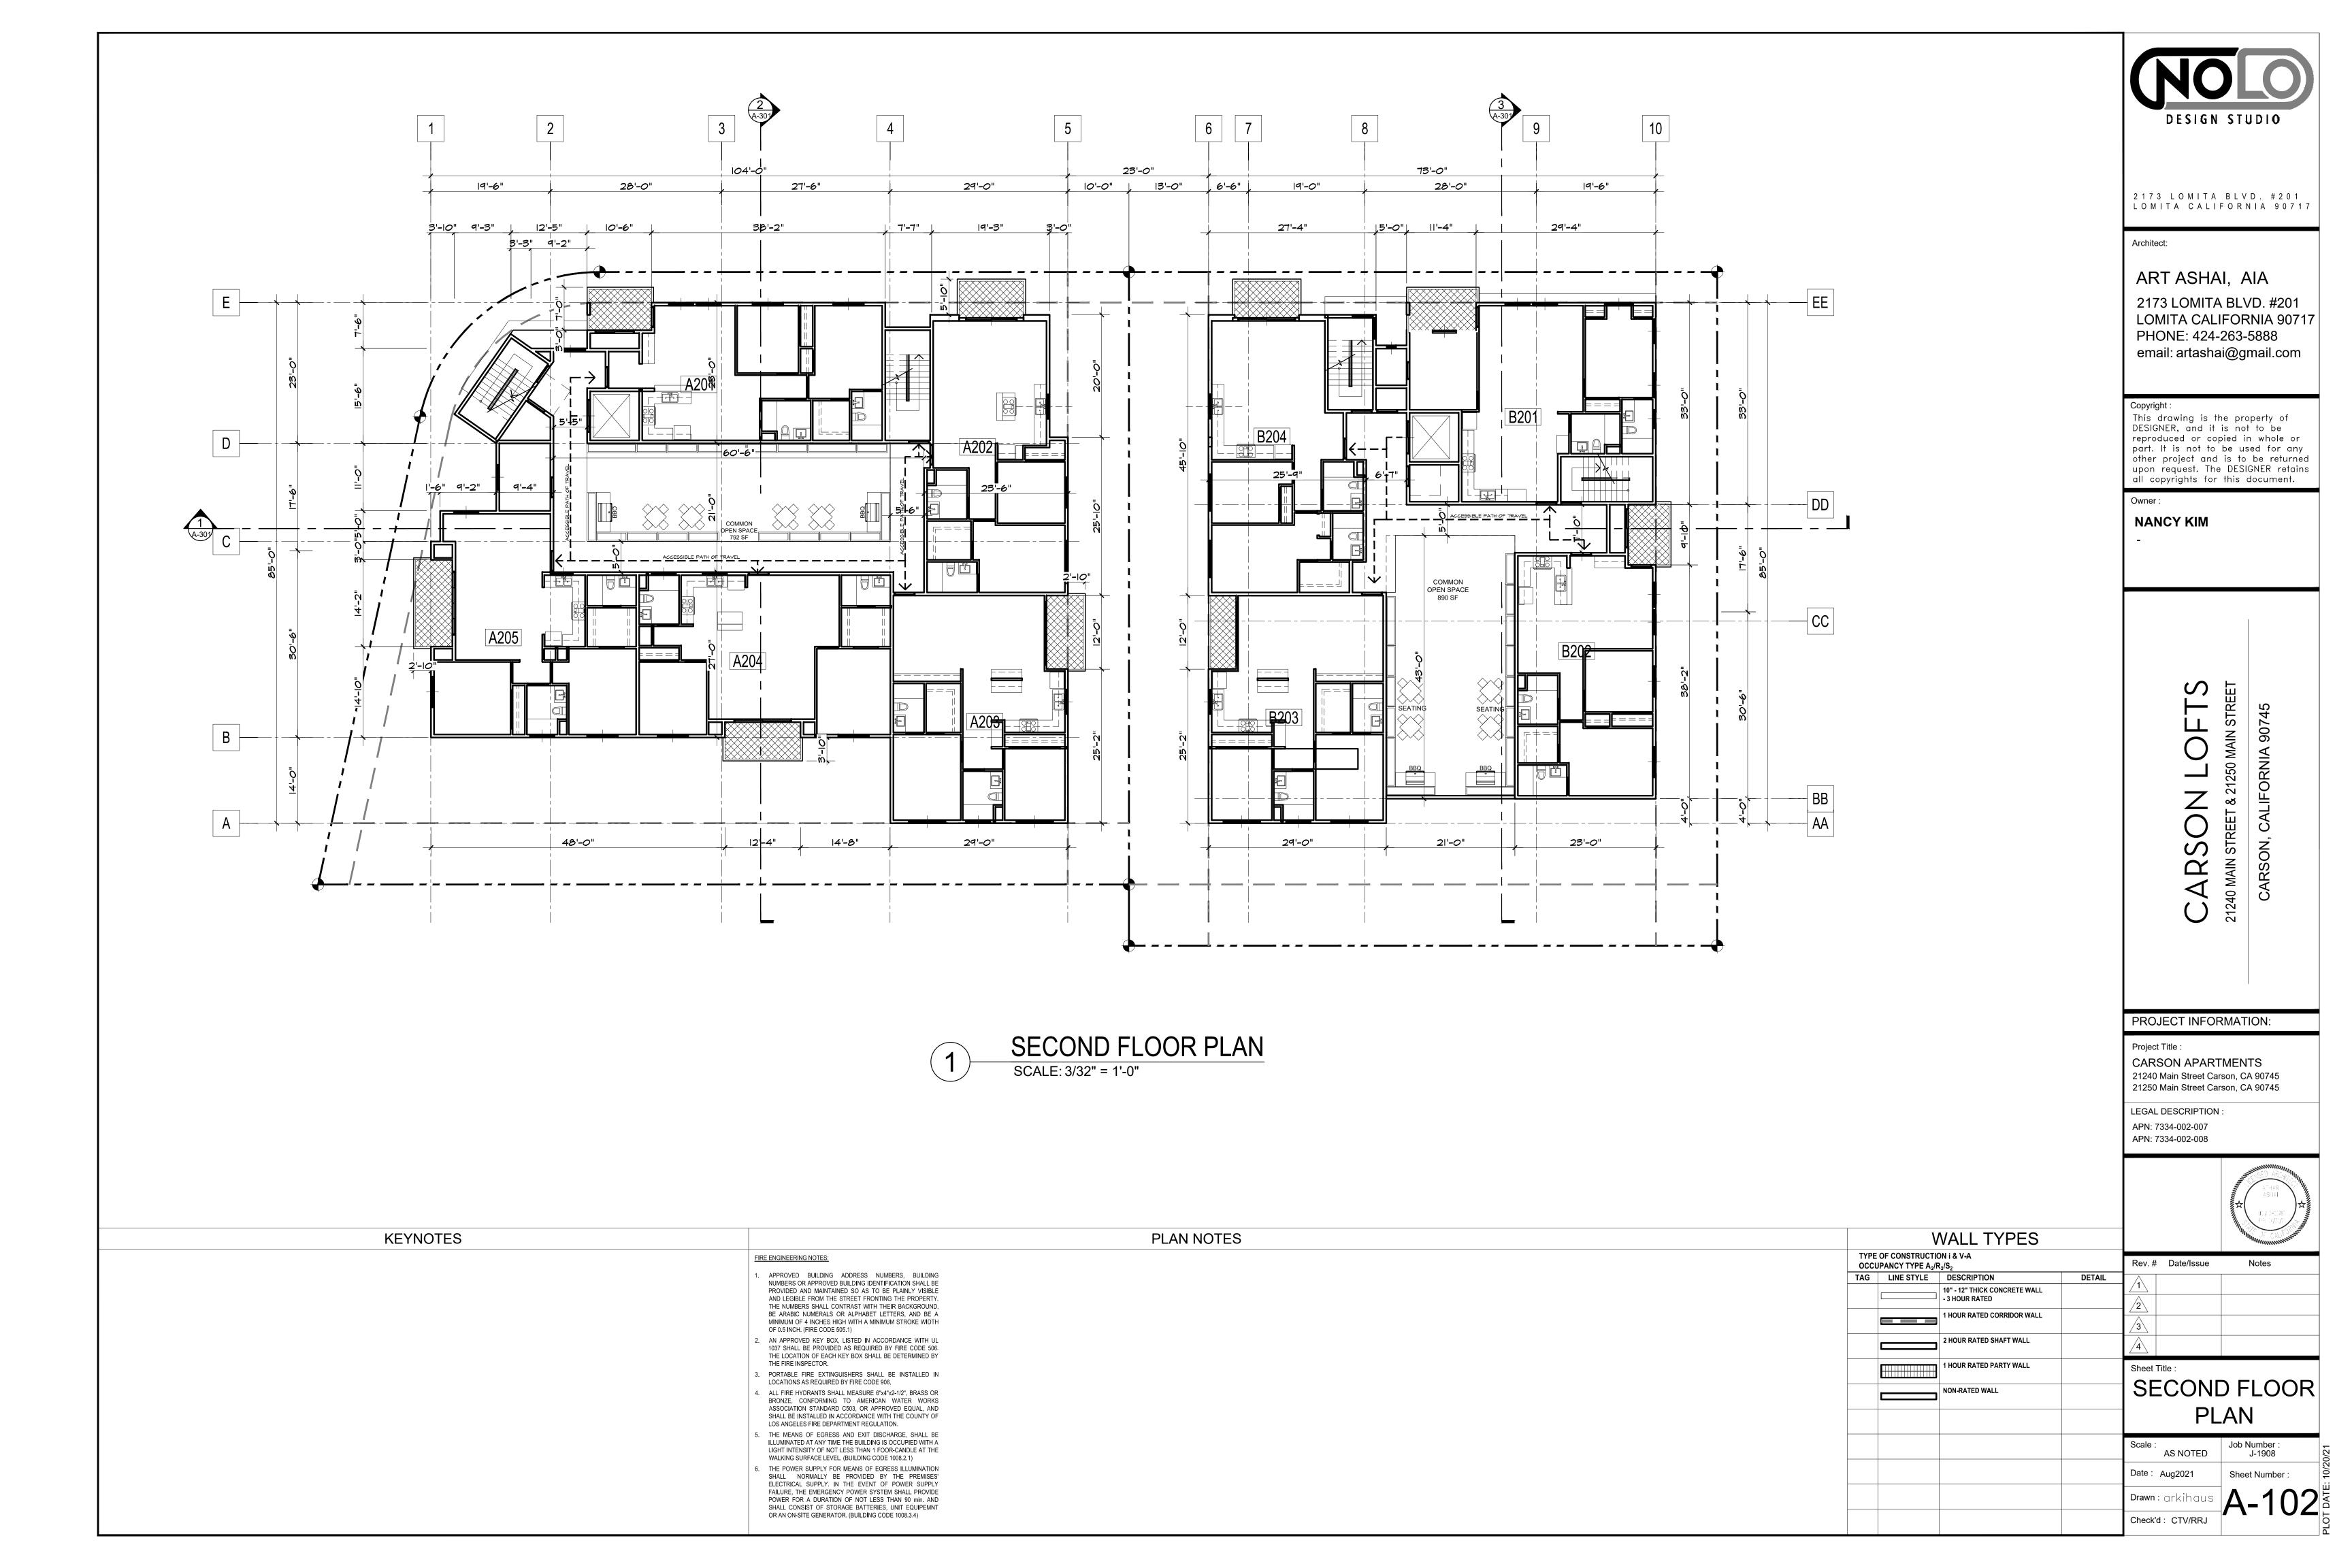

FIRE ENGINEERING NOTES:

OF 0.5 INCH. (FIRE CODE 505.1)

THE FIRE INSPECTOR.

APPROVED BUILDING ADDRESS NUMBERS, BUILDING NUMBERS OR APPROVED BUILDING IDENTIFICATION SHALL BE

PROVIDED AND MAINTAINED SO AS TO BE PLAINLY VISIBLE

MINIMUM OF 4 INCHES HIGH WITH A MINIMUM STROKE WIDTH

AN APPROVED KEY BOX, LISTED IN ACCORDANCE WITH UL

1037 SHALL BE PROVIDED AS REQUIRED BY FIRE CODE 506. THE LOCATION OF EACH KEY BOX SHALL BE DETERMINED BY

PORTABLE FIRE EXTINGUISHERS SHALL BE INSTALLED IN

ALL FIRE HYDRANTS SHALL MEASURE 6"x4"x2-1/2", BRASS OR BRONZE, CONFORMING TO AMERICAN WATER WORKS ASSOCIATION STANDARD C503, OR APPROVED EQUAL, AND

SHALL BE INSTALLED IN ACCORDANCE WITH THE COUNTY OF

5. THE MEANS OF EGRESS AND EXIT DISCHARGE, SHALL BE ILLUMINATED AT ANY TIME THE BUILDING IS OCCUPIED WITH A LIGHT INTENSITY OF NOT LESS THAN 1 FOOR-CANDLE AT THE

SHALL NORMALLY BE PROVIDED BY THE PREMISES' ELECTRICAL SUPPLY. IN THE EVENT OF POWER SUPPLY FAILURE, THE EMERGENCY POWER SYSTEM SHALL PROVIDE

POWER FOR A DURATION OF NOT LESS THAN 90 min. AND SHALL CONSIST OF STORAGE BATTERIES, UNIT EQUIPEMNT OR AN ON-SITE GENERATOR. (BUILDING CODE 1008.3.4)

WALKING SURFACE LEVEL. (BUILDING CODE 1008.2.1) THE POWER SUPPLY FOR MEANS OF EGRESS ILLUMINATION

LOCATIONS AS REQUIRED BY FIRE CODE 906.

LOS ANGELES FIRE DEPARTMENT REGULATION.

AND LEGIBLE FROM THE STREET FRONTING THE PROPERTY. THE NUMBERS SHALL CONTRAST WITH THEIR BACKGROUND, BE ARABIC NUMERALS OR ALPHABET LETTERS, AND BE A 21250 Main Street Carson, CA 90745 LEGAL DESCRIPTION APN: 7334-002-007 APN: 7334-002-008

21240 MAIN STREET

Project Title:

CARSON APARTMENTS 21240 Main Street Carson, CA 90745

DESIGN STUDIO

LOMITA CALIFORNIA 90717


email: artashai@gmail.com


Architect:


WALL TYPES TYPE OF CONSTRUCTION i & V-A Rev. # Date/Issue OCCUPANCY TYPE A₂/R₂/S₂ TAG LINE STYLE DESCRIPTION DETAIL 10" - 12" THICK CONCRETE WALL 1 HOUR RATED CORRIDOR WALL 2 HOUR RATED SHAFT WALL 1 HOUR RATED PARTY WALL Sheet Title : THIRD FLOOR NON-RATED WALL PLAN

AS NOTED J-1908 Date: Aug2021 Sheet Number: Drawn: arkihaus

Check'd: CTV/RRJ

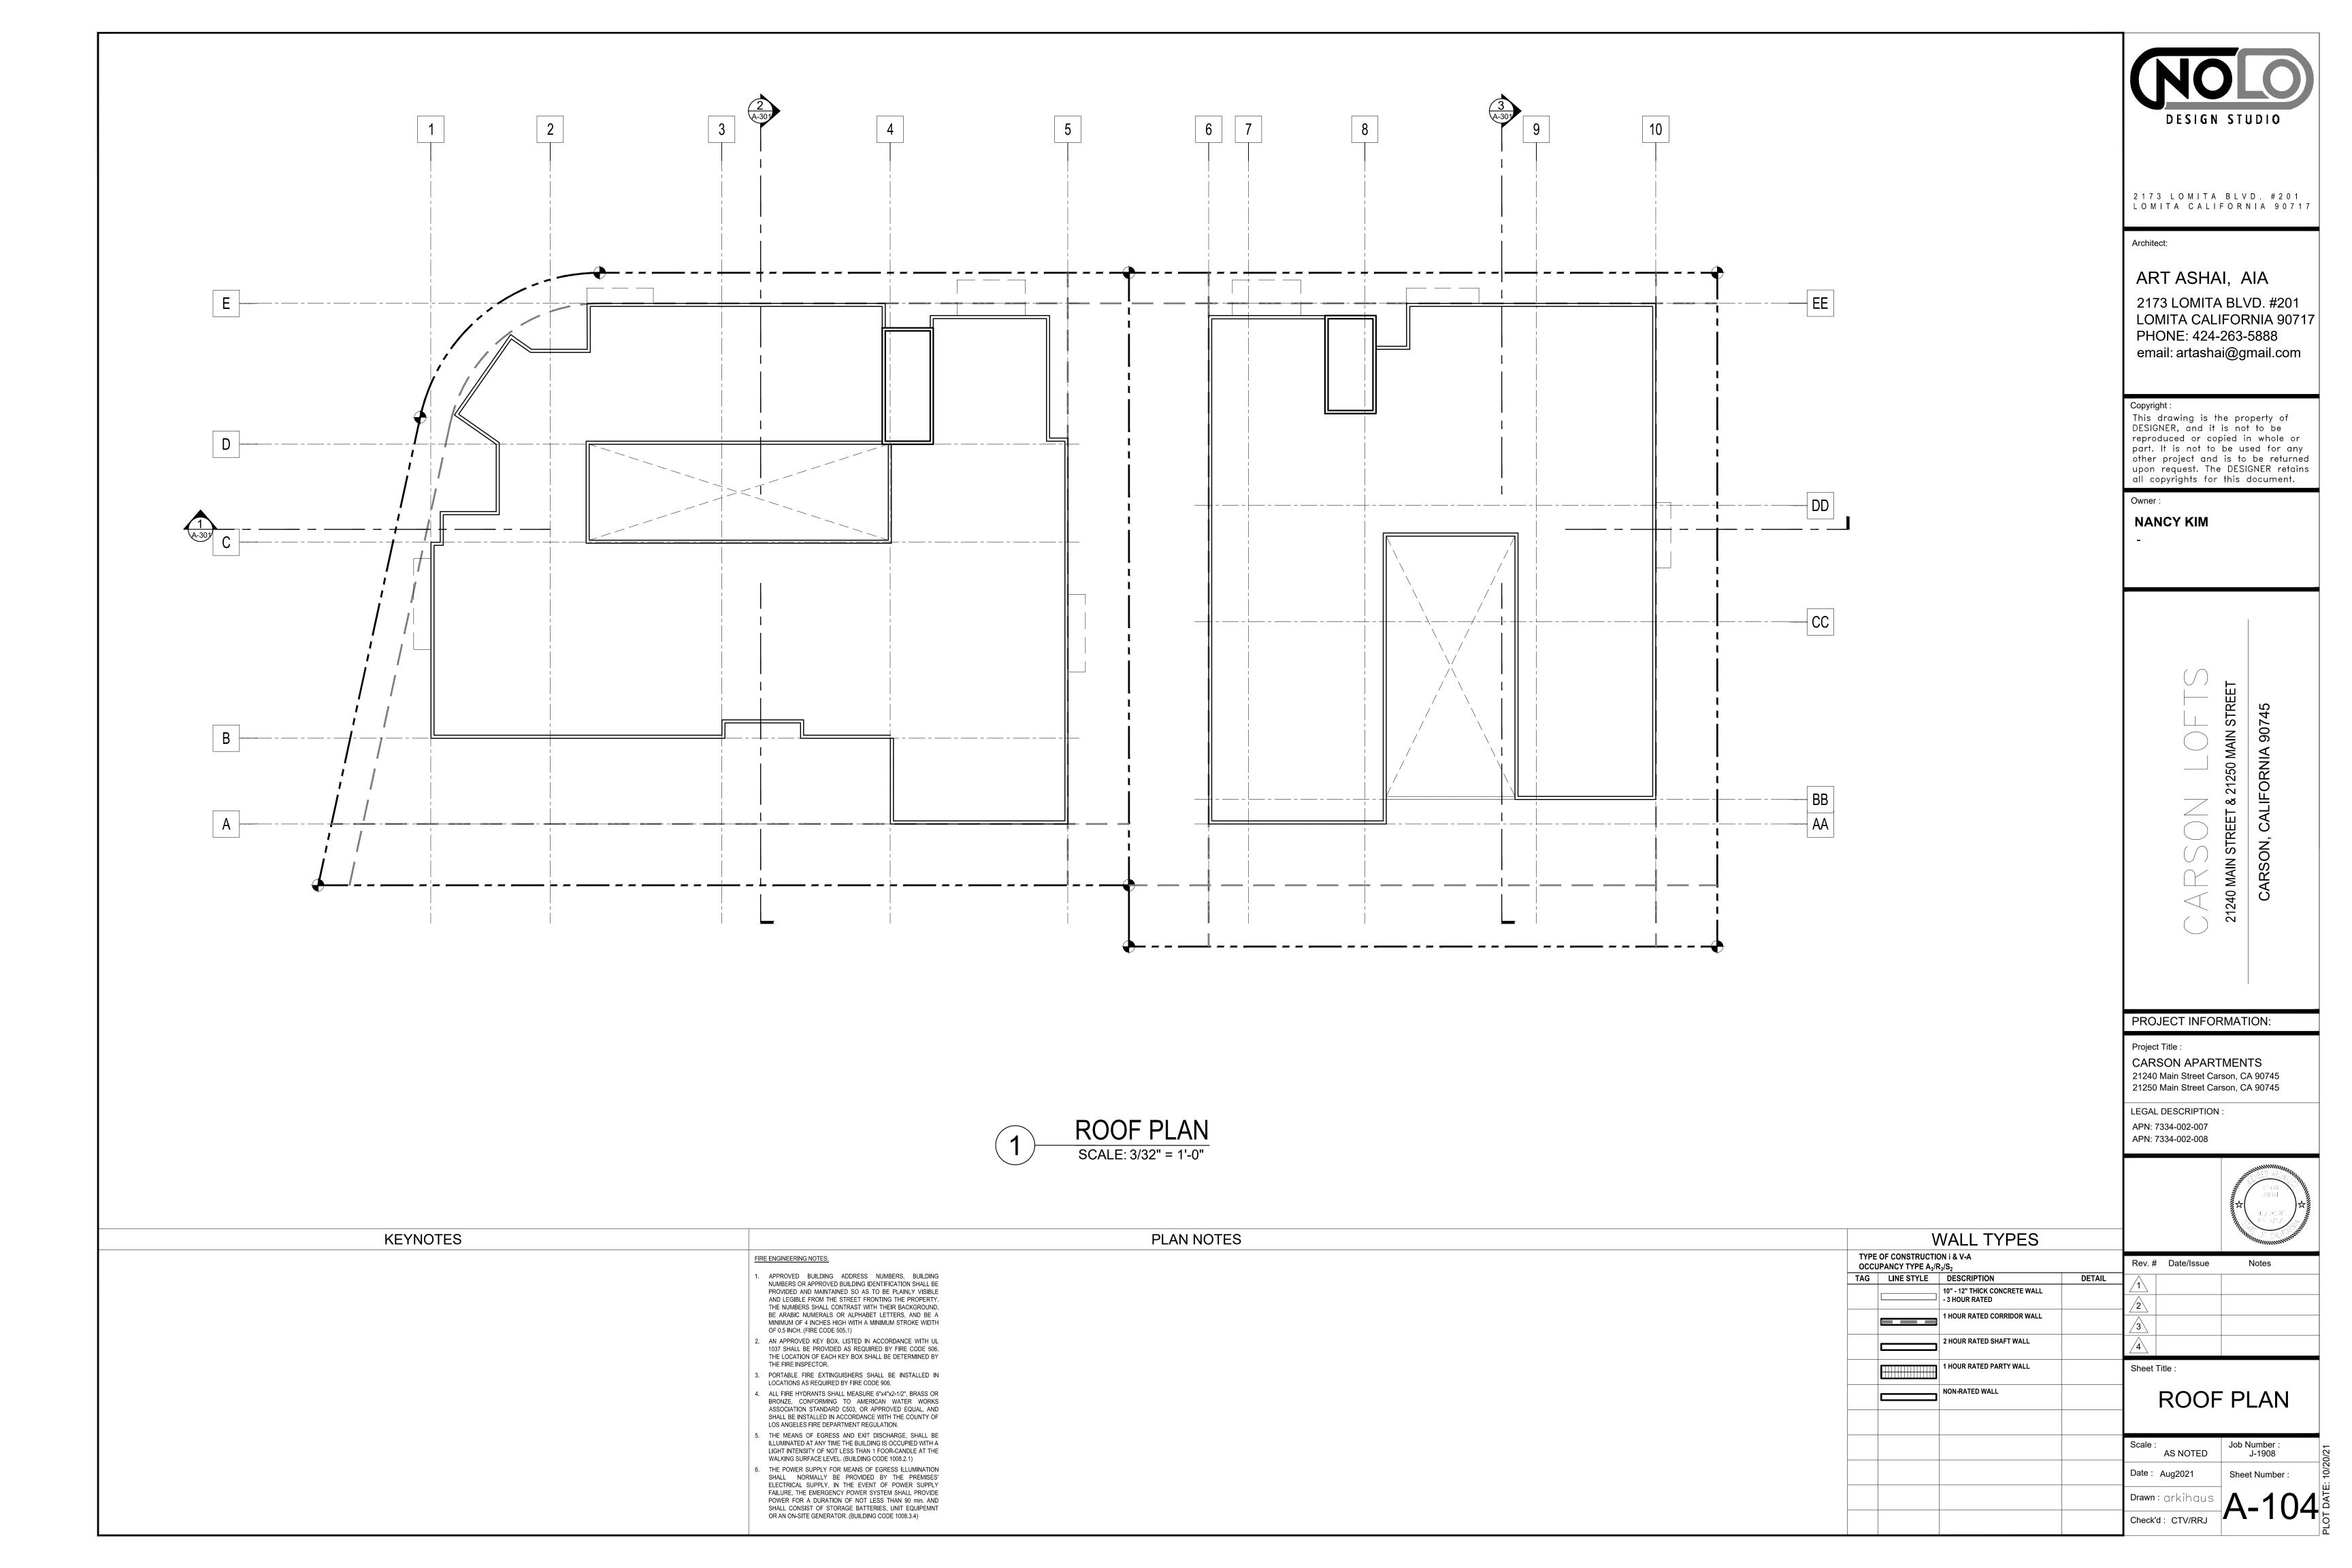


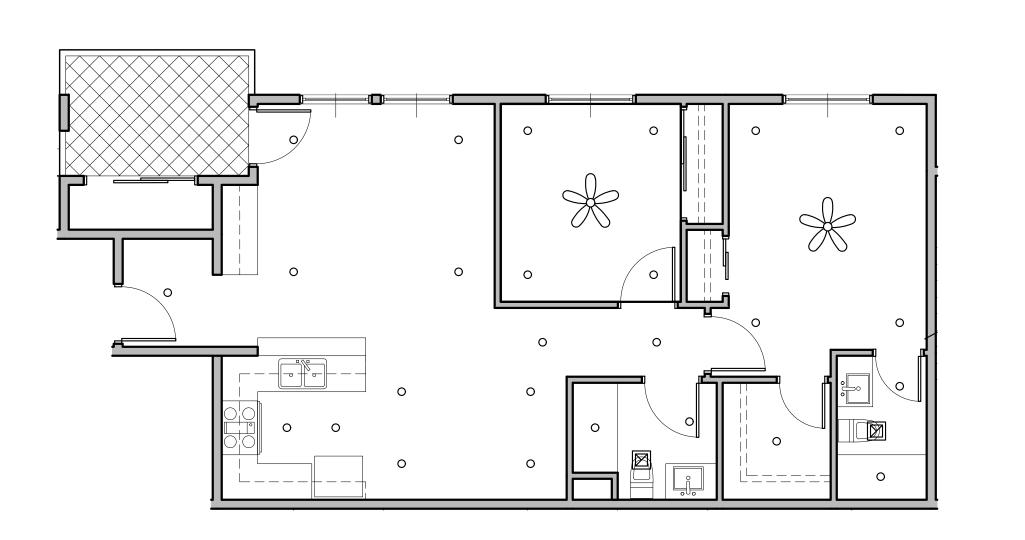


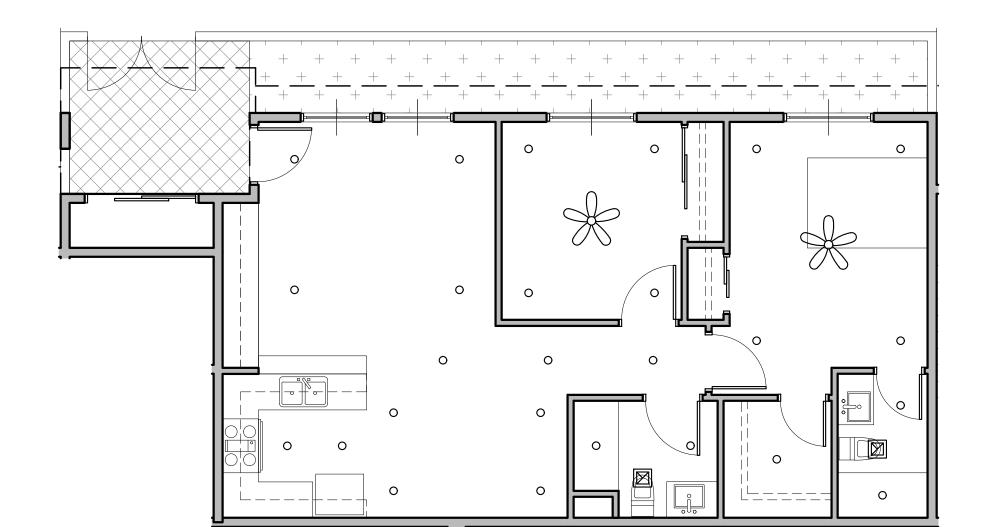

UNIT PLAN 201, 301 - REFLECTED CEILING PLAN



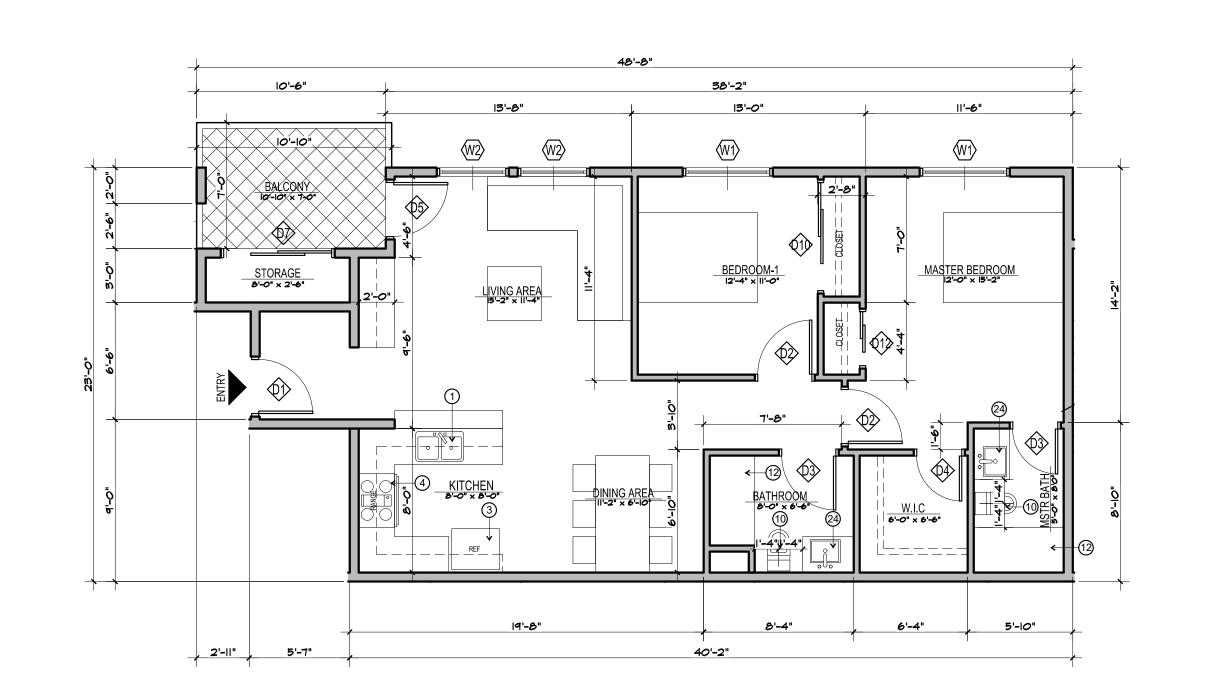

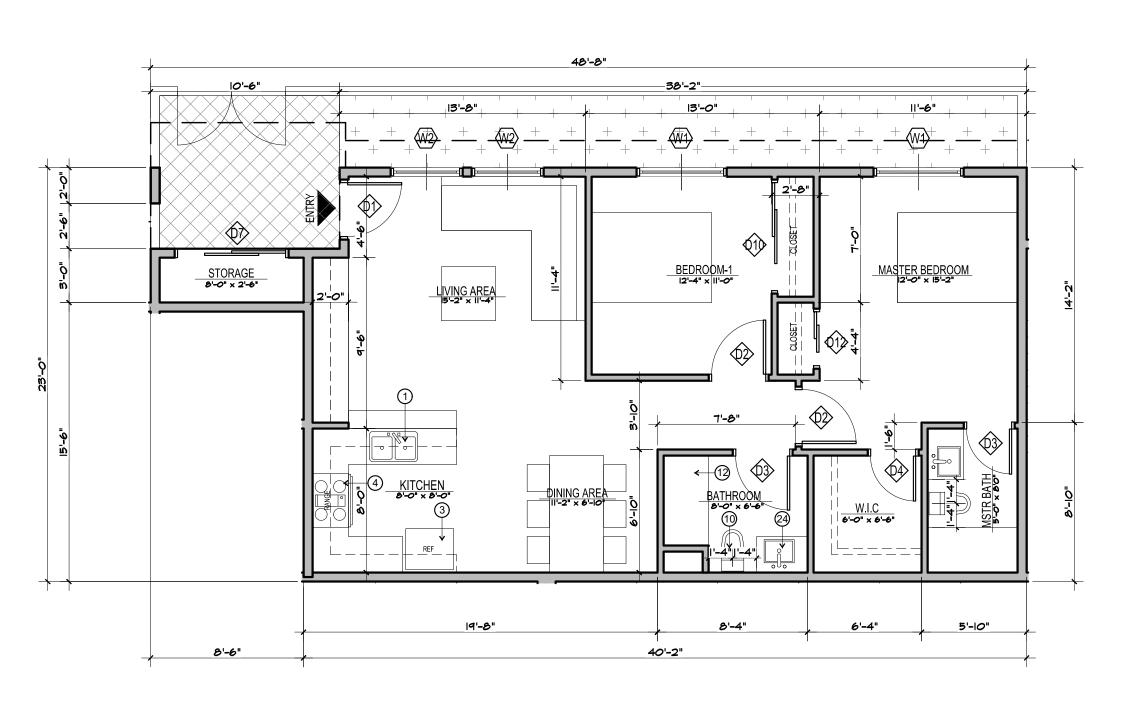

GENERAL NOTES

- DWELLING UNITS ACCESSIBILITY, REFER TO SHEET A-
- COMMON AN PUBLIC AREAS ACCESSIBILITY, REFER TO SHEETS A- AND A-ALL TUB/SHOWER COMBOS WILL BE UTILIZED FIBERGLASS.
 WALLS ARE PERMITTED TO BE OF NON-RATED CONSTRUCTION EXCEPTS AS GRAPHICALLY NOTED ON BUILI
- COMPOSITE FLOOR PLANS. UNITS SHALL HAVE AT LEAST A MINIMUM LEAKAGE OF 0.30 CFM50 PER SQUARE FOOT OF ENCLOSURE.
- WATER HEATER UNIT MODEL SEE PLUMBING SCHEDULE. RECESSED LIGHTING SHALL BE "BOXED IN" AT FIRE RATED FLOOR/CLG CONDITIONS DIMENSIONS ARE MEASURED FROM FACE OF STUD (FOS) UNLESS NOTED OTHERWISE.

ELEMENT	DESCRIPTION
TYPE A	5/8" GYPSUM BOAR - TAPE, TEXTURE AND PAINT - SATIN LEVEL FIN
TYPE B	5/8" GYPSUM BOAR - TAPE, TEXTURE AND PAINT - SEMI GLOSS LEVEL 4 FIN
TYPE C	EXTERIOR SOFFIT 5/8 " GYP BOARD TYPR X - TAPE, TEXTURE STUCCO FINISH
	LIMIT OF SOFFIT ABOVE - HEIGHT PER FLOOR PLAN. REFER TO DET 14 & 15/A-
1/2"	FLOOR LEVEL AT DOORS SHALL NOT BE MORE THAN $\frac{1}{2}$ INCH LOWER THAN THRESHOLD AT THE DOORWAY PER C.B.C. SECTION 1008.1.6 AND 1132A. 4.1
HS C	FLOOR MATERIAL FLUSH TRANSITION
A A	INTERIOR ELEVATION KEY
IVING ROOM CARPET 9'-0"	ROOM NAME — FLOOR FINISH — CEILING HEIGHT
(00)	DOOR NUMBER - REFER TO DOOR SCHEDULE
200	WINDOW TYPE - REFER TO WINDOW SCHEDULE
0	RECESSED LIGHT FIXTURE (AT AND IC RATED)
H	CEILING FAN
	SUPPLY AIR REGISTER
] →→	SUPPLY AIR SIDE WALL REGISTER
	RETURN AIR REGISTER
	RETURN AIR SIDE WALL REGISTER
	EXHAUST AIR REGISTER / FAN - ENERGY STAR COMPLIANT - SEE MECH
©D	SMOKE DETECTOR

UNIT PLAN KEYNOTES

DOUBLE BOWL SINK W WITH GARAGE DISPOSAL & HOLE FOR DISHWASHER AIR GAP. PROVIDE ADAPTABLE REQUIREMENTS WHERE NOTED/ REFER TO SCHEDULE OF FINISHES.

CARBON MONOXIDE DETECTOR

- UNDER-COUNTER +/ -- 24" WIDE DISHWASHER (BOSCH 24" ADA OR APPROVED EQUAL. ENERGY STAR CERTIFIED). PROVIDE ADAPTABLE REQUIREMENTS. REFER TO SCHEDULE OF FINISHES.
- REFRIGERATOR SPACE. PROVIDE COLD WATER STUB-OUT IN RECESSED WALL BOX FOR ICE MAKER. PROVIDE 1-HR RATED WALL RECESS WHERE OCCURS IN 1-HR RATED WALL ASSEMBLY. PROVIDE ADAPTABLE REQUIREMENTS. REFER TO SCHEDULE OF FINISHES.

WALL TYPE SYMBOL. - SEE SCHEDULE ON SHEET A-- AND A-

- FREE STANDING RANGE AND OVER THE RANGE MICROWAVE (BOTH ENERGY STAR CERTIFIED) VERIFY AND INSTALL APPLIANCES PER MANUFACTURER'S REQUIREMENTS. PROVIDE ADAPTABLE REQUIREMENTS. PROVIDE
- (5) 24" DEEP BASE CABINET WITH COUNTERTOP
- 6) 12" DEEP UPPER CABINET

3/16" = 1'-0"

- 7) ENERGY STAR WASHER AND DRYER STACKED 8 VOID SPACE, FILL IN WITH INSULATION
- 9 ULTRA-LOW FLUSH TOILET REFER TO DETAIL FOR ACCESSIBILITY
- (10) 32" x 60" TUB/SHOWER VERIFY UNIT DIMENSIONS WITH MANUFACTURER PRIOR TO FRAMING
- RECESSED MEDICINE CABINET. PROVIDE 1- HR RATED WALL RECESS WHERE OCCURS IN 1 -HR RATED WALL FUTURE 36" GRAB BAR. PROVIDE SOLID BLOCKING CONCEALED WITHIN WALL CENTERED ON BAR LOCATION
- 3) FUTURE 42" GRAB BAR. PROVIDE SOLID BLOCKING CONCEALED WITHIN WALL CENTERED ON BAR LOCATION
- 4) ELECTRIC PANEL REFER TO ELECTRICAL DRAWINGS FOR SOME INFORMATION
- STUD BAY AT EACH END & CENTER OF POLE FOR POLE HARDWARE. VERIFY SHELF BRACKETS & PROVIDE CONCEALED 2x BLOCKING ACCORDINGLY.
- CEILING MOUNTED HORIZONTAL FAN COIL UNIT. (SEE MECHANICAL PLANS) VERIFY UNIT DIMENSIONS AND CLEARANCE REQUIREMENTS PRIOR TO FRAMING AND SETTING DROPPED CEILING HEIGHT. PROVIDE MINIMUM REQUIRED MANUFACTURE ACCESS PANEL COMPATIBLE WITH F.C.U. PAINT PANEL TO MATCH CEILING.
- METAL THRESHOLD. FLOOR LEVEL CHANGES GREATER THAN 1 AT DOORWAYS SHALL BE BEVELED OR SLOPE NOT GREATER THAN ONE UNIT VERTICAL IN TWO UNITS HORIZONTAL (50% SLOPE). REFER TO DETAILS AT ENTRY DOOR AT BALCONY SLIDING DOOR
- 19) UNIT DOOR BELL AT +48"AFF SEE ELEC
- (20) ACCESSIBLE COMPLIANT LAVATORY
- (21) UNIT SIGNAGE
- 22) WATER SUB METER AT HIGH LEVEL INSIDE CEILING SPACE WITH CEILING ACCESS SEE PLUMBING DUAL REMOTE WATER METER DISPLAY. MOUNT HT. AT 4' - 0". ABOVE FINISH FLOOR TO TOP OF DISPLAY
- 25) ENERGY STAR TANKLESS WATER HEATER. SEE PLUMBING DRAWINGS. VERIFY REQUIRED CLEARANCES WITH MFR PRIOR TO FRAMING
- (26) SMOKE DETECTOR
- 27) CARBON MONOXIDE DETECTOR 28) 42" HIGH GUARD RAIL - REFER TO EXTERIOR ELEVATIONS.
- (29) EXTERIOR LOW WALL REFER TO EXTERIOR ELEVATION
- 30) 1HR RATED SHAFT CONTRACTOR TO VERIFY WITH MECHANICAL DRAWINGS
- (31) EXTERIOR EXHAUST LOUVER SEE MECHANICAL
- (32) GUTTER

SCALE

3/16" = 1'-0"

- (33) SCUPPER
- (34) CEILING BREAK
- (35) 2" WIDE PVC SOFFIT VENT SEE DETAIL
- (36) NOT USED



2173 LOMITA BLVD. #201 LOMITA CALIFORNIA 90717

ART ASHAI, AIA

2173 LOMITA BLVD. #201 LOMITA CALIFORNIA 90717 PHONE: 424-263-5888

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NANCY KIM

& 21250 21240 MAIN STREE

PROJECT INFORMATION:

21250 Main Street Carson, CA 90745

CARSON APARTMENTS 21240 Main Street Carson, CA 90745

LEGAL DESCRIPTION APN: 7334-002-007

APN: 7334-002-008




Rev.#	Date/Issue	Notes
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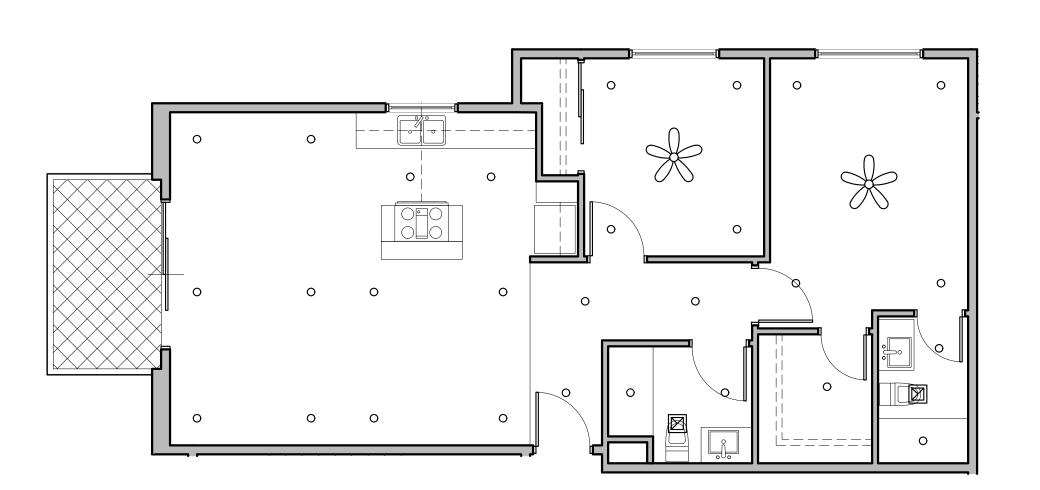
BUILDING A-UNIT PLANS

AS NOTED J-1908 Date: Aug2021 Drawn: arkihaus Check'd: CTV/RRJ


SCALE
3/16" = 1'-0"

O3 UNIT PLAN 101 - FLOOR PLAN UNIT PLAN 201, 301 - FLOOR PLAN




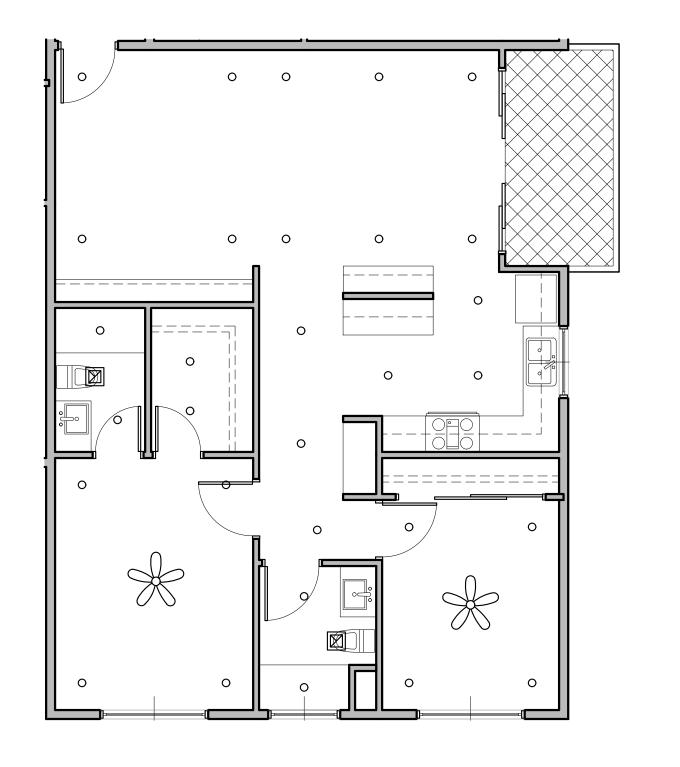


UNIT PLAN 203, 303 - REFLECTED CEILING PLAN

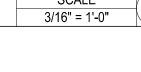

UNIT PLAN 202, 302 - REFLECTED CEILING PLAN

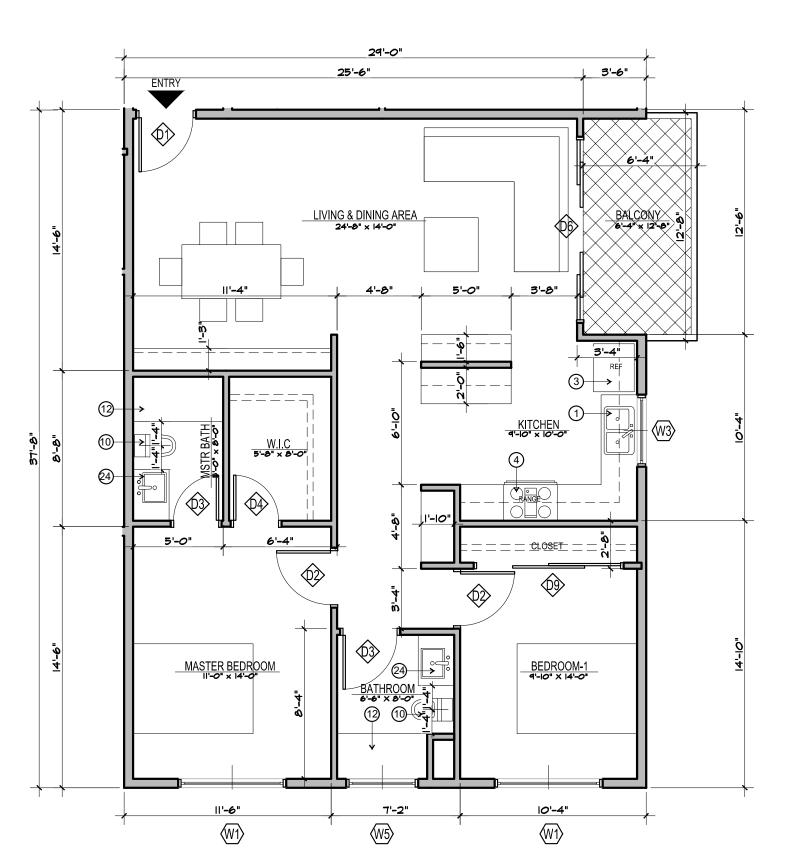

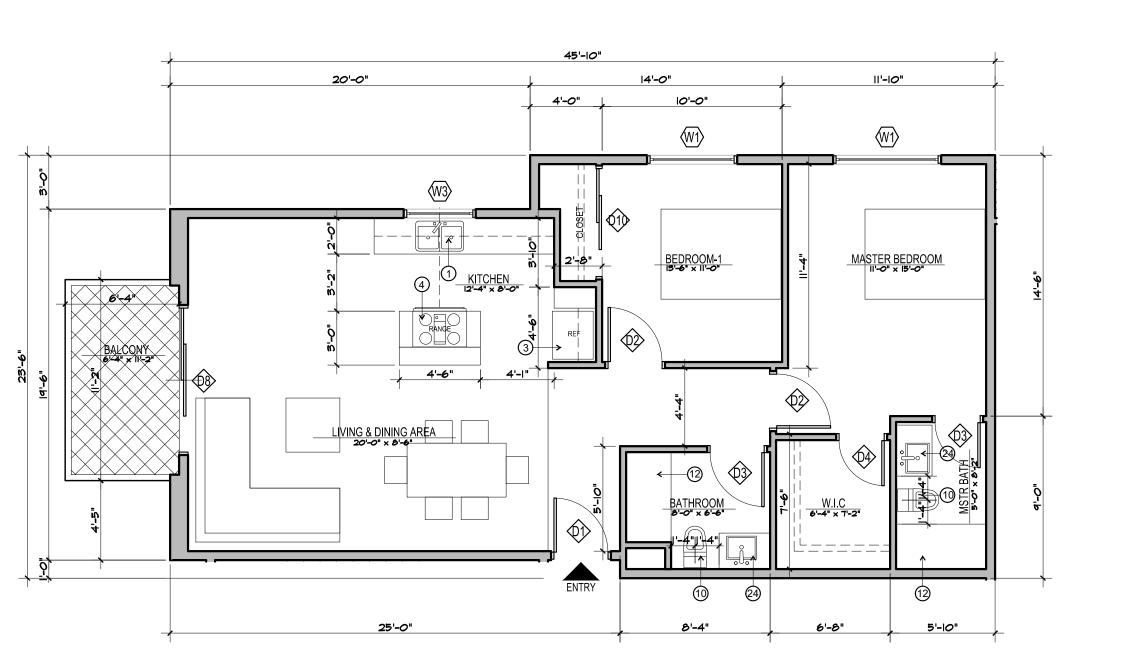

GENERAL NOTES

- DWELLING UNITS ACCESSIBILITY, REFER TO SHEET A-
- COMMON AN PUBLIC AREAS ACCESSIBILITY, REFER TO SHEETS A- AND A-
- ALL TUB/SHOWER COMBOS WILL BE UTILIZED FIBERGLASS. WALLS ARE PERMITTED TO BE OF NON-RATED CONSTRUCTION EXCEPTS AS GRAPHICALLY NOTED ON BUIL COMPOSITE FLOOR PLANS.
- UNITS SHALL HAVE AT LEAST A MINIMUM LEAKAGE OF 0.30 CFM50 PER SQUARE FOOT OF ENCLOSURE. WATER HEATER UNIT MODEL SEE PLUMBING SCHEDULE.
- RECESSED LIGHTING SHALL BE "BOXED IN" AT FIRE RATED FLOOR/CLG CONDITIONS 8. DIMENSIONS ARE MEASURED FROM FACE OF STUD (FOS) UNLESS NOTED OTHERWISE.

UNIT PLAN LEGEND

5/8" GYPSUM BOAR - TAPE, TEXTURE AND PAINT -SATIN LEVEL FIN 5/8" GYPSUM BOAR - TAPE, TEXTURE AND PAINT -SEMI GLOSS LEVEL 4 FIN EXTERIOR SOFFIT 5/8 " GYP BOARD TYPR X - TAPE, TEXTURE STUCCO FINISH LIMIT OF SOFFIT ABOVE - HEIGHT PER FLOOR PLAN. REFER TO FLOOR LEVEL AT DOORS SHALL NOT BE MORE THAN $\frac{1}{2}$ INCH LOWER THAN FLOOR MATERIAL FLUSH TRANSITION INTERIOR ELEVATION KEY LIVING ROOM ROOM NAME CARPET FLOOR FINISH
9'-0" CEILING HEIGHT DOOR NUMBER - REFER TO DOOR SCHEDULE WINDOW TYPE - REFER TO WINDOW SCHEDULE RECESSED LIGHT FIXTURE (AT AND IC RATED) SUPPLY AIR REGISTER SUPPLY AIR SIDE WALL REGISTER RETURN AIR REGISTER RETURN AIR SIDE WALL REGISTER EXHAUST AIR REGISTER / FAN - ENERGY STAR COMPLIANT - SEE MECH SMOKE DETECTOR CARBON MONOXIDE DETECTOR WALL TYPE SYMBOL. - SEE SCHEDULE ON SHEET A- AND A-

UNIT PLAN KEYNOTES

- DOUBLE BOWL SINK W WITH GARAGE DISPOSAL & HOLE FOR DISHWASHER AIR GAP. PROVIDE ADAPTABLE REQUIREMENTS WHERE NOTED/ REFER TO SCHEDULE OF FINISHES.
- UNDER-COUNTER +/ $\,-$ 24" WIDE DISHWASHER (BOSCH 24" ADA OR APPROVED EQUAL. ENERGY STAR CERTIFIED). PROVIDE ADAPTABLE REQUIREMENTS. REFER TO SCHEDULE OF FINISHES.
- REFRIGERATOR SPACE. PROVIDE COLD WATER STUB-OUT IN RECESSED WALL BOX FOR ICE MAKER. PROVIDE 1-HR RATED WALL RECESS WHERE OCCURS IN 1-HR RATED WALL ASSEMBLY. PROVIDE ADAPTABLE REQUIREMENTS. REFER TO SCHEDULE OF FINISHES.
- FREE STANDING RANGE AND OVER THE RANGE MICROWAVE (BOTH ENERGY STAR CERTIFIED) VERIFY AND INSTALL APPLIANCES PER MANUFACTURER'S REQUIREMENTS. PROVIDE ADAPTABLE REQUIREMENTS. PROVIDE
- (5) 24" DEEP BASE CABINET WITH COUNTERTOP
- 6 12" DEEP UPPER CABINET

3/16" = 1'-0"

- (7) ENERGY STAR WASHER AND DRYER STACKED 8 VOID SPACE, FILL IN WITH INSULATION
- (9) ULTRA-LOW FLUSH TOILET REFER TO DETAIL FOR ACCESSIBILITY
- (10) 32" x 60" TUB/SHOWER VERIFY UNIT DIMENSIONS WITH MANUFACTURER PRIOR TO FRAMING
- RECESSED MEDICINE CABINET. PROVIDE 1- HR RATED WALL RECESS WHERE OCCURS IN 1 -HR RATED WALL
- FUTURE 36" GRAB BAR. PROVIDE SOLID BLOCKING CONCEALED WITHIN WALL CENTERED ON BAR LOCATION
- (13) FUTURE 42" GRAB BAR. PROVIDE SOLID BLOCKING CONCEALED WITHIN WALL CENTERED ON BAR LOCATION
- 14) ELECTRIC PANEL REFER TO ELECTRICAL DRAWINGS FOR SOME INFORMATION
- STUD BAY AT EACH END & CENTER OF POLE FOR POLE HARDWARE. VERIFY SHELF BRACKETS & PROVIDE CONCEALED 2x BLOCKING ACCORDINGLY.
- CEILING MOUNTED HORIZONTAL FAN COIL UNIT. (SEE MECHANICAL PLANS) VERIFY UNIT DIMENSIONS AND CLEARANCE REQUIREMENTS PRIOR TO FRAMING AND SETTING DROPPED CEILING HEIGHT. PROVIDE MINIMUM REQUIRED MANUFACTURE ACCESS PANEL COMPATIBLE WITH F.C.U. PAINT PANEL TO MATCH CEILING.
- 8 METAL THRESHOLD. FLOOR LEVEL CHANGES GREATER THAN ‡" AT DOORWAYS SHALL BE BEVELED OR SLOPE NOT GREATER THAN ONE UNIT VERTICAL IN TWO UNITS HORIZONTAL (50% SLOPE). REFER TO DETAILS AT ENTRY DOOR AT BALCONY SLIDING DOOF
- 19) UNIT DOOR BELL AT +48"AFF SEE ELEC
- (20) ACCESSIBLE COMPLIANT LAVATORY
- (21) UNIT SIGNAGE
- 22) WATER SUB METER AT HIGH LEVEL INSIDE CEILING SPACE WITH CEILING ACCESS SEE PLUMBING DUAL REMOTE WATER METER DISPLAY. MOUNT HT. AT 4' - 0". ABOVE FINISH FLOOR TO TOP OF DISPLAY
- (24) 15" MIN. BREADBOARD
- 25) ENERGY STAR TANKLESS WATER HEATER. SEE PLUMBING DRAWINGS. VERIFY REQUIRED CLEARANCES WITH MFR PRIOR TO FRAMING
- (26) SMOKE DETECTOR
- (27) CARBON MONOXIDE DETECTOR
- (28) 42" HIGH GUARD RAIL REFER TO EXTERIOR ELEVATIONS. (29) EXTERIOR LOW WALL - REFER TO EXTERIOR ELEVATION
- (30) 1HR RATED SHAFT CONTRACTOR TO VERIFY WITH MECHANICAL DRAWINGS
- (31) EXTERIOR EXHAUST LOUVER SEE MECHANICAL (32) GUTTER
- (33) SCUPPER
- (34) CEILING BREAK
- (35) 2" WIDE PVC SOFFIT VENT SEE DETAIL
- (36) NOT USED

SCALE



2173 LOMITA BLVD. #201

LOMITA CALIFORNIA 90717

Architect:

ART ASHAI, AIA

2173 LOMITA BLVD. #201 LOMITA CALIFORNIA 90717 PHONE: 424-263-5888

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NANCY KIM

STREET

∘ŏ 21240 MAIN STREE

PROJECT INFORMATION:


CARSON APARTMENTS

21240 Main Street Carson, CA 90745

21250 Main Street Carson, CA 90745

LEGAL DESCRIPTION APN: 7334-002-007

APN: 7334-002-008

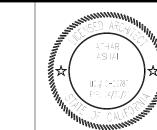


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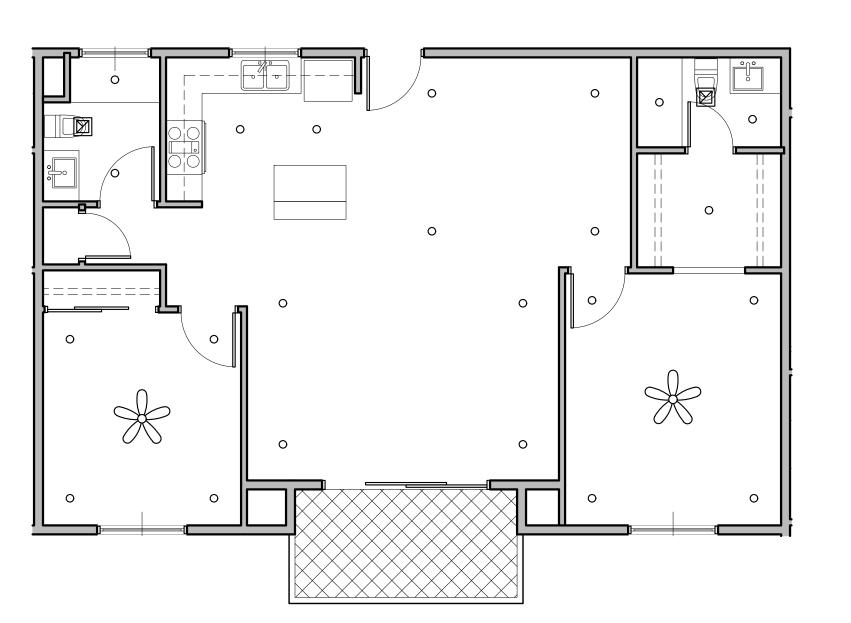
BUILDING A-UNIT PLANS

AS NOTED J-1908 Date: Aug2021 Drawn: arkihaus Check'd: CTV/RRJ


UNIT PLAN 203, 303 - FLOOR PLAN


UNIT PLAN 202, 302 - FLOOR PLAN



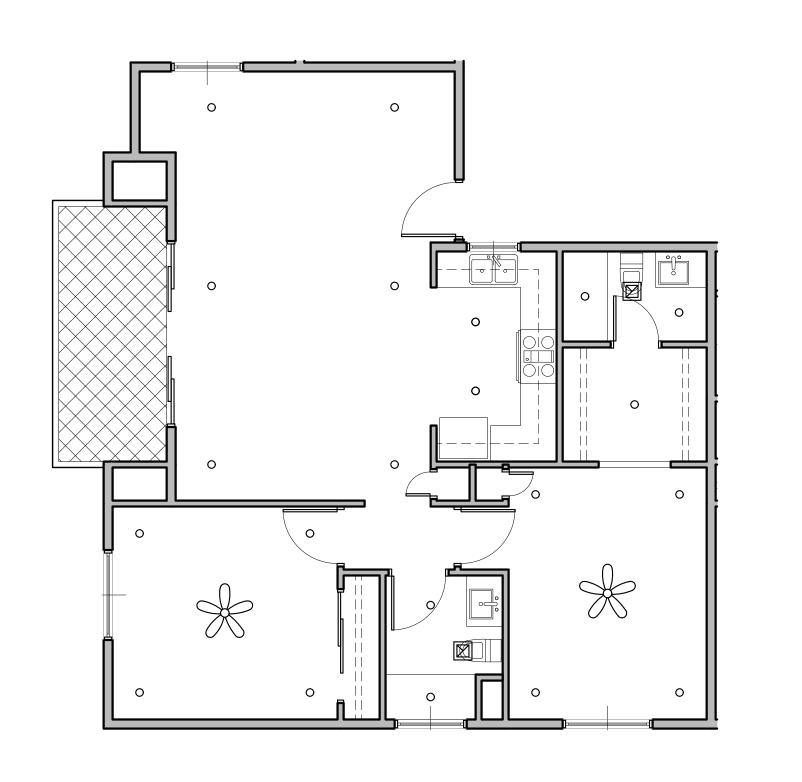

UNIT PLAN 205, 305 - REFLECTED CEILING PLAN

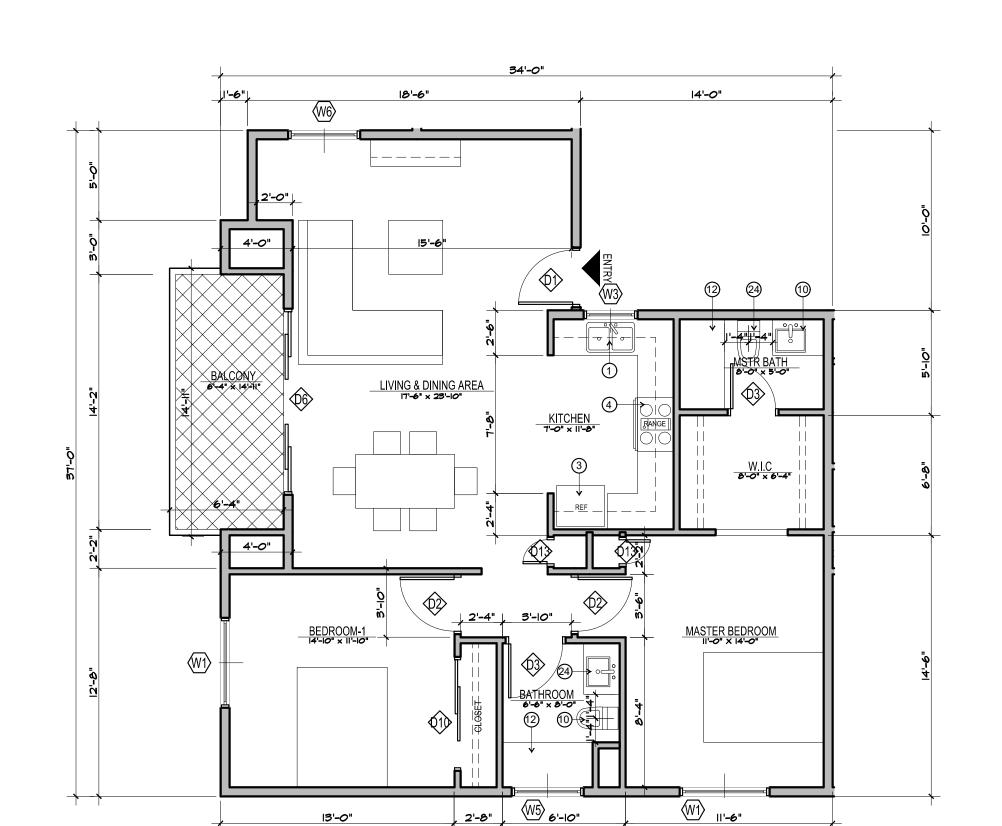

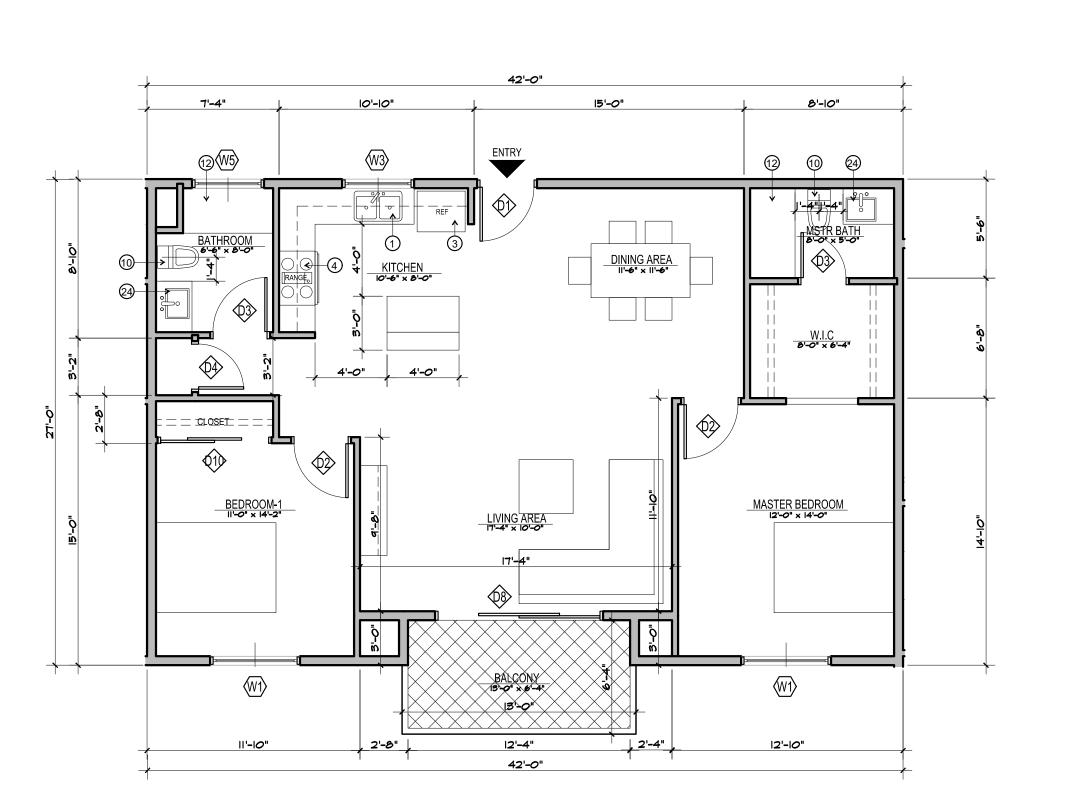

GENERAL NOTES

- 1. DWELLING UNITS ACCESSIBILITY, REFER TO SHEET A-
- . DWELLING UNITS ACCESSIBILITY, REFER TO SHEET A. COMMON AN PUBLIC AREAS ACCESSIBILITY, REFER TO SHEETS A- AND A-
- ALL TUB/SHOWER COMBOS WILL BE UTILIZED FIBERGLASS.
 WALLS ARE PERMITTED TO BE OF NON-RATED CONSTRUCTION EXCEPTS AS GRAPHICALLY NOTED ON BUILD GOVERNORE FLOOR BY AND.
- COMPOSITE FLOOR PLANS.
 UNITS SHALL HAVE AT LEAST A MINIMUM LEAKAGE OF 0.30 CFM50 PER SQUARE FOOT OF ENCLOSURE.
- 6. WATER HEATER UNIT MODEL SEE PLUMBING SCHEDULE.
 7. RECESSED LIGHTING SHALL BE "BOXED IN" AT FIRE RATED FLOOR/CLG CONDITIONS
 8. DIMENSIONS ARE MEASURED FROM FACE OF STUD (FOS) UNLESS NOTED OTHERWISE.

UNIT PLAN LEGEND

ELEMENT	DESCRIPTION
TYPE A	5/8" GYPSUM BOAR - TAPE, TEXTURE AND PAINT - SATIN LEVEL FIN
TYPE B	5/8" GYPSUM BOAR - TAPE, TEXTURE AND PAINT - SEMI GLOSS LEVEL 4 FIN
TYPE C	EXTERIOR SOFFIT 5/8 " GYP BOARD TYPR X - TAPE, TEXTURE STUCCO FINISH
	LIMIT OF SOFFIT ABOVE - HEIGHT PER FLOOR PLAN. REFER TO DET 14 & 15/A
1/2"	FLOOR LEVEL AT DOORS SHALL NOT BE MORE THAN $\frac{1}{2}$ INCH LOWER THAN THRESHOLD AT THE DOORWAY PER C.B.C. SECTION 1008.1.6 AND 1132A. 4.1
HS C	FLOOR MATERIAL FLUSH TRANSITION
A A A	INTERIOR ELEVATION KEY
LIVING ROOM CARPET 9' - 0"	ROOM NAME FLOOR FINISH CEILING HEIGHT
(00)	DOOR NUMBER - REFER TO DOOR SCHEDULE
<u></u>	WINDOW TYPE - REFER TO WINDOW SCHEDULE
0	RECESSED LIGHT FIXTURE (AT AND IC RATED)
H	CEILING FAN
	SUPPLY AIR REGISTER
□ →→	SUPPLY AIR SIDE WALL REGISTER
	RETURN AIR REGISTER
	RETURN AIR SIDE WALL REGISTER
	EXHAUST AIR REGISTER / FAN - ENERGY STAR COMPLIANT - SEE MECH
<u>s</u>	SMOKE DETECTOR
<u>©</u>	CARBON MONOXIDE DETECTOR
(WA)	WALL TYPE SYMBOL SEE SCHEDULE ON SHEET A- AND A-

UNIT PLAN KEYNOTES

- 1 DOUBLE BOWL SINK W WITH GARAGE DISPOSAL & HOLE FOR DISHWASHER AIR GAP. PROVIDE ADAPTABLE REQUIREMENTS WHERE NOTED/REFER TO SCHEDULE OF FINISHES.
- 2 UNDER-COUNTER +/ 24" WIDE DISHWASHER (BOSCH 24" ADA OR APPROVED EQUAL. ENERGY STAR CERTIFIED). PROVIDE ADAPTABLE REQUIREMENTS. REFER TO SCHEDULE OF FINISHES.
- REFER TO SCHEDULE OF FINISHES.

 REFRIGERATOR SPACE. PROVIDE COLD WATER STUB-OUT IN RECESSED WALL BOX FOR ICE MAKER. PROVIDE
- 1-HR RATED WALL RECESS WHERE OCCURS IN 1-HR RATED WALL ASSEMBLY. PROVIDE ADAPTABLE REQUIREMENTS. REFER TO SCHEDULE OF FINISHES.
- FREE STANDING RANGE AND OVER THE RANGE MICROWAVE (BOTH ENERGY STAR CERTIFIED) -- VERIFY AND INSTALL APPLIANCES PER MANUFACTURER'S REQUIREMENTS. PROVIDE ADAPTABLE REQUIREMENTS. PROVIDE 15" BREADBOARD EA SIDE.
- (5) 24" DEEP BASE CABINET WITH COUNTERTOP
- 6 12" DEEP UPPER CABINET

3/16" = 1'-0"

- 7 ENERGY STAR WASHER AND DRYER STACKED
- VOID SPACE, FILL IN WITH INSULATION
 ULTRA-LOW FLUSH TOILET REFER TO DETAIL
- REQUIREMENTS
- (10) 32" x 60" TUB/SHOWER VERIFY UNIT DIMENSIONS WITH MANUFACTURER PRIOR TO FRAMING
- 11 RECESSED MEDICINE CABINET. PROVIDE 1- HR RATED WALL RECESS WHERE OCCURS IN 1 -HR RATED WALL ASSEMBLY
 (12) FUTURE 36" GRAB BAR. PROVIDE SOLID BLOCKING CONCEALED WITHIN WALL CENTERED ON BAR LOCATION
- (13) FUTURE 42" GRAB BAR. PROVIDE SOLID BLOCKING CONCEALED WITHIN WALL CENTERED ON BAR LOCATION
- (14) ELECTRIC PANEL REFER TO ELECTRICAL DRAWINGS FOR SOME INFORMATION POLE AND SHELF. LOCATE POLE 66" ABOVE FINISH FLOOR. PROVIDE 2x6 BLOCKING WITHIN
- 15) STUD BAY AT EACH END & CENTER OF POLE FOR POLE HARDWARE. VERIFY SHELF BRACKETS & PROVIDE
- (16) GRAB BAR
- (7) CEILING MOUNTED HORIZONTAL FAN COIL UNIT. (SEE MECHANICAL PLANS) VERIFY UNIT DIMENSIONS AND CLEARANCE REQUIREMENTS PRIOR TO FRAMING AND SETTING DROPPED CEILING HEIGHT. PROVIDE MINIMUM REQUIRED MANUFACTURE ACCESS PANEL COMPATIBLE WITH F.C.U. PAINT PANEL TO MATCH CEILING.
- METAL THRESHOLD. FLOOR LEVEL CHANGES GREATER THAN 4" AT DOORWAYS SHALL BE BEVELED OR SLOPED NOT GREATER THAN ONE UNIT VERTICAL IN TWO UNITS HORIZONTAL (50% SLOPE). REFER TO DETAILS AT ENTRY DOOR AT BALCONY SLIDING DOOR

 21240 Main Street Carson, CA 90745
- (19) UNIT DOOR BELL AT +48"AFF SEE ELEC
- 20 ACCESSIBLE COMPLIANT LAVATORY
- 21 UNIT SIGNAGE
- 22) WATER SUB METER AT HIGH LEVEL INSIDE CEILING SPACE WITH CEILING ACCESS SEE PLUMBING
- DUAL REMOTE WATER METER DISPLAY. MOUNT HT. AT 4' 0". ABOVE FINISH FLOOR TO TOP OF DISPLAY
 15" MIN. BREADBOARD
- 25 ENERGY STAR TANKLESS WATER HEATER. SEE PLUMBING DRAWINGS.
- VERIFY REQUIRED CLI
 (26) SMOKE DETECTOR
- 27 CARBON MONOXIDE DETECTOR
- 42" HIGH GUARD RAIL REFER TO EXTERIOR ELEVATIONS.
 EXTERIOR LOW WALL REFER TO EXTERIOR ELEVATION
- (30) 1HR RATED SHAFT CONTRACTOR TO VERIFY WITH MECHANICAL DRAWINGS
- (31) EXTERIOR EXHAUST LOUVER SEE MECHANICAL
- 32 GUTTER
- 33 SCUPPER
 34 CEILING BREAK
- (35) 2" WIDE PVC SOFFIT VENT SEE DETAIL
- 36 NOT USED



2173 LOMITA BLVD. #201 LOMITA CALIFORNIA 90717

Architect:

ART ASHAI, AIA

2173 LOMITA BLVD. #201 LOMITA CALIFORNIA 90717 PHONE: 424-263-5888 email: artashai@gmail.com

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/ner :

NANCY KIM


21240 MAIN STREET & 21250 MAIN STREET

PROJECT INFORMATION:

CARSON APARTMENTS
21240 Main Street Carson, CA 90745

LEGAL DESCRIPTION

APN: 7334-002-007 APN: 7334-002-008

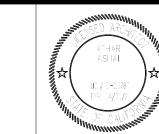

Rev.#	Date/Iss	ue	Notes
1			
2			
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BUILDING A-

Scale:
AS NOTED

Job Number:
J-1908

Date: Aug2021

Sheet Number:

Check'd: CTV/RRJ


UNIT PLANS


UNIT PLAN 205, 305 - FLOOR PLAN

OS UNIT PLAN 204, 304 - FLOOR PLAN

UNIT PLAN 204, 304 - REFLECTED CEILING PLAN


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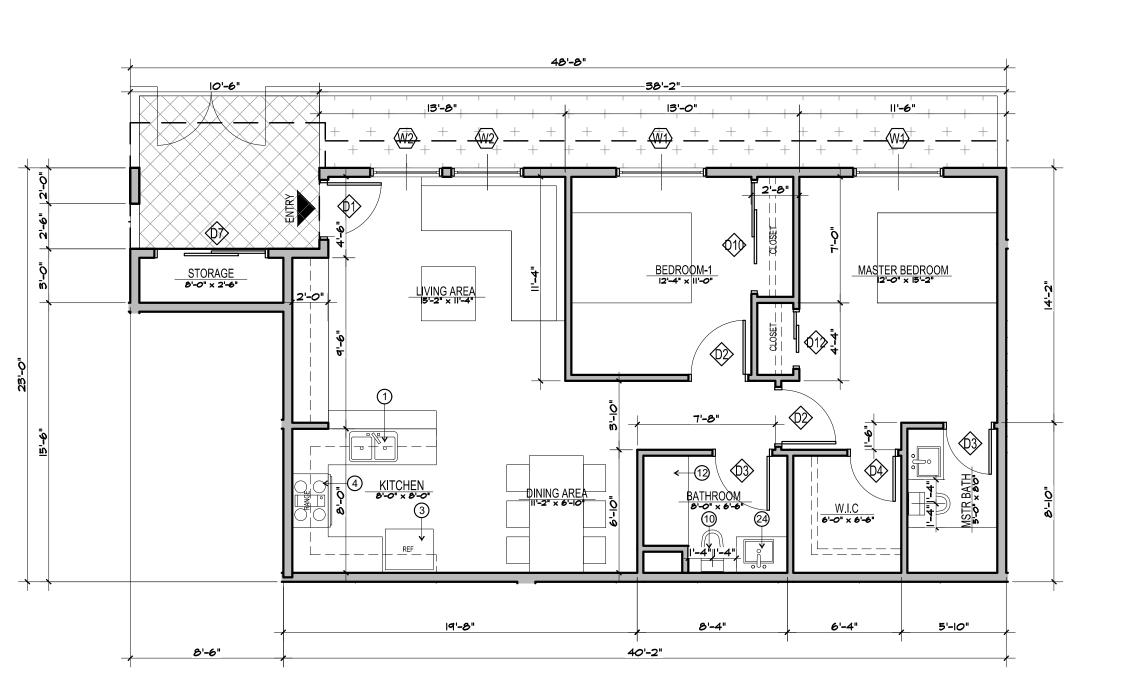


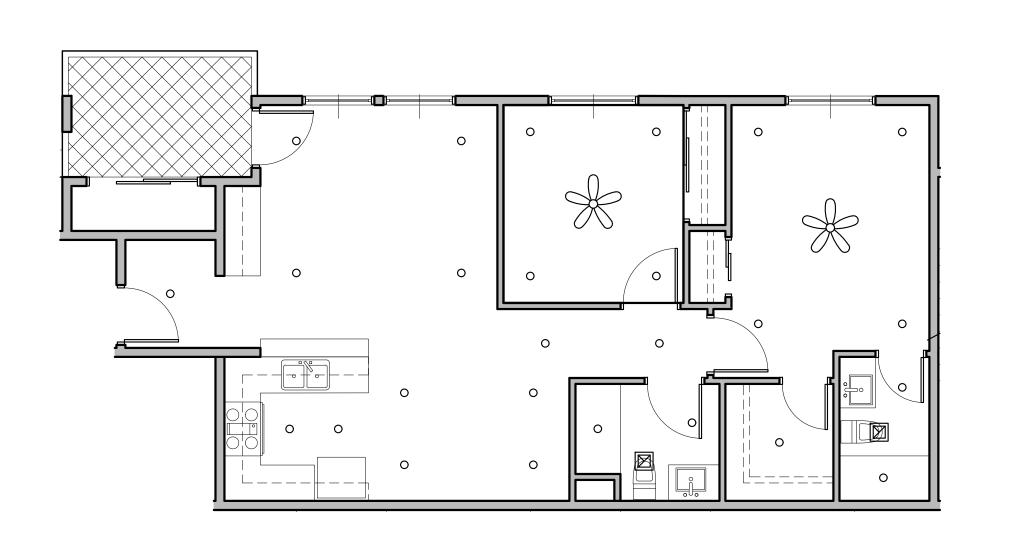

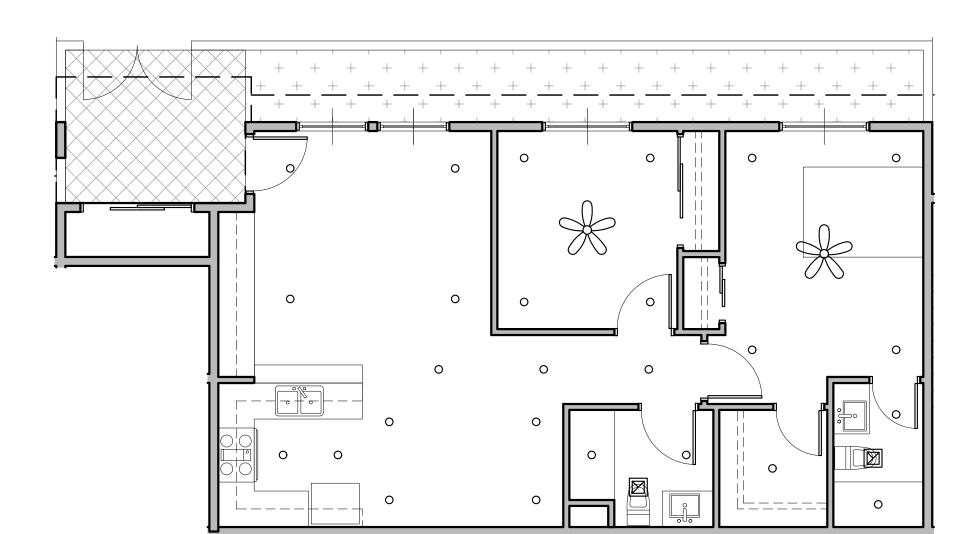UNIT PLAN 201, 301 - REFLECTED CEILING PLAN

UNIT PLAN 101 - REFLECTED CEILING PLAN



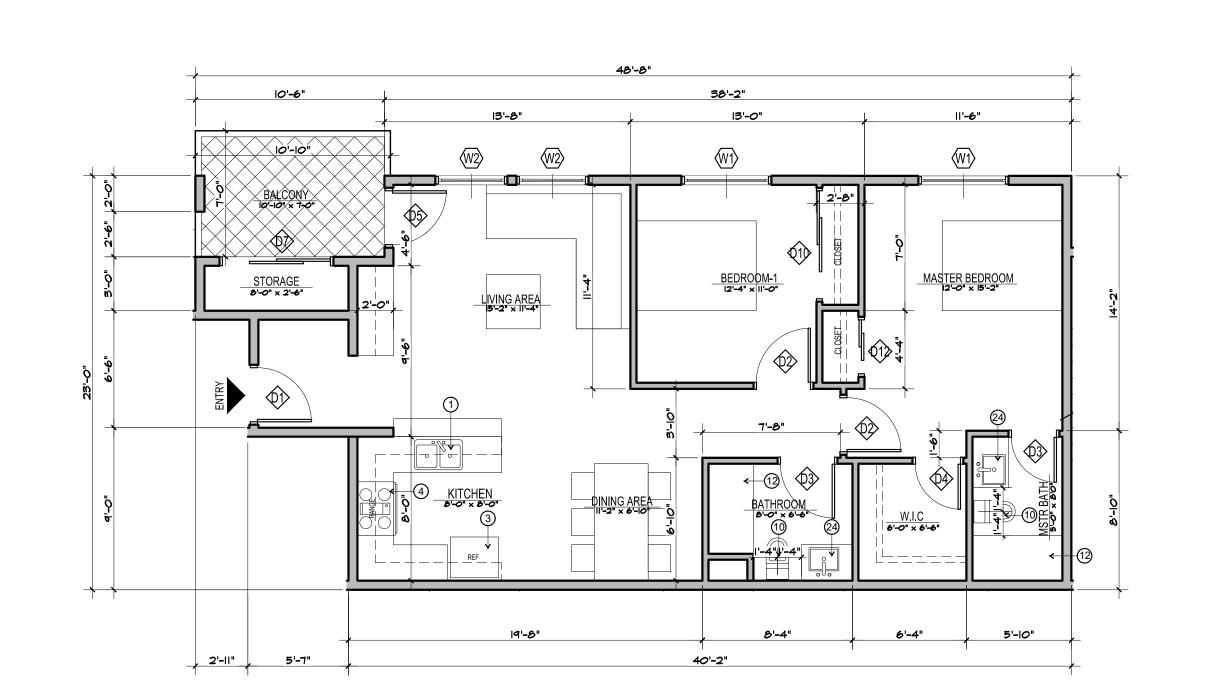

GENERAL NOTES

- COMMON AN PUBLIC AREAS ACCESSIBILITY, REFER TO SHEETS A- AND A-
- ALL TUB/SHOWER COMBOS WILL BE UTILIZED FIBERGLASS. . WALLS ARE PERMITTED TO BE OF NON-RATED CONSTRUCTION EXCEPTS AS GRAPHICALLY NOTED ON BUI COMPOSITE FLOOR PLANS.
- UNITS SHALL HAVE AT LEAST A MINIMUM LEAKAGE OF 0.30 CFM50 PER SQUARE FOOT OF ENCLOSURE.
 WATER HEATER UNIT MODEL SEE PLUMBING SCHEDULE.
- RECESSED LIGHTING SHALL BE "BOXED IN" AT FIRE RATED FLOOR/CLG CONDITIONS 3. DIMENSIONS ARE MEASURED FROM FACE OF STUD (FOS) UNLESS NOTED OTHERWISE.

ELEMENT	DESCRIPTION
TYPE A	5/8" GYPSUM BOAR - TAPE, TEXTURE AND PAINT - SATIN LEVEL FIN
TYPE B	5/8" GYPSUM BOAR - TAPE, TEXTURE AND PAINT - SEMI GLOSS LEVEL 4 FIN
TYPE C	EXTERIOR SOFFIT 5/8 " GYP BOARD TYPR X - TAPE, TEXTURE STUCCO FINISH
	LIMIT OF SOFFIT ABOVE - HEIGHT PER FLOOR PLAN. REFER TO DET 14 & 15/A
1/2"	FLOOR LEVEL AT DOORS SHALL NOT BE MORE THAN $\frac{1}{2}$ INCH LOWER THAN THRESHOLD AT THE DOORWAY PER C.B.C. SECTION 1008.1.6 AND 1132A. 4.1
HS C	FLOOR MATERIAL FLUSH TRANSITION
A A A	INTERIOR ELEVATION KEY
LIVING ROOM CARPET 9'-0"	ROOM NAME FLOOR FINISH CEILING HEIGHT
00>	DOOR NUMBER - REFER TO DOOR SCHEDULE
00	WINDOW TYPE - REFER TO WINDOW SCHEDULE
0	RECESSED LIGHT FIXTURE (AT AND IC RATED)
	CEILING FAN
	SUPPLY AIR REGISTER
□ →→	SUPPLY AIR SIDE WALL REGISTER
	RETURN AIR REGISTER
	RETURN AIR SIDE WALL REGISTER
	EXHAUST AIR REGISTER / FAN - ENERGY STAR COMPLIANT - SEE MECH
©	SMOKE DETECTOR

UNIT PLAN KEYNOTES

DOUBLE BOWL SINK W WITH GARAGE DISPOSAL & HOLE FOR DISHWASHER AIR GAP. PROVIDE ADAPTABLE REQUIREMENTS WHERE NOTED/REFER TO SCHEDULE OF FINISHES.

CARBON MONOXIDE DETECTOR

- UNDER-COUNTER $\pm 1/2$ WIDE DISHWASHER (BOSCH 24" ADA OR APPROVED EQUAL. ENERGY STAR CERTIFIED). PROVIDE ADAPTABLE REQUIREMENTS. REFER TO SCHEDULE OF FINISHES.
- REFRIGERATOR SPACE. PROVIDE COLD WATER STUB-OUT IN RECESSED WALL BOX FOR ICE MAKER. PROVIDE

WALL TYPE SYMBOL. - SEE SCHEDULE ON SHEET A- AND A-

- 1-HR RATED WALL RECESS WHERE OCCURS IN 1-HR RATED WALL ASSEMBLY. PROVIDE ADAPTABLE REQUIREMENTS. REFER TO SCHEDULE OF FINISHES. FREE STANDING RANGE AND OVER THE RANGE MICROWAVE (BOTH ENERGY STAR CERTIFIED) -- VERIFY AND
- INSTALL APPLIANCES PER MANUFACTURER'S REQUIREMENTS. PROVIDE ADAPTABLE REQUIREMENTS. PROVIDE
- 5 24" DEEP BASE CABINET WITH COUNTERTOP
- 6 12" DEEP UPPER CABINET
- 7) ENERGY STAR WASHER AND DRYER STACKED 8 VOID SPACE, FILL IN WITH INSULATION
- ULTRA-LOW FLUSH TOILET REFER TO DETAIL FOR ACCESSIBILITY REQUIREMENTS
- (10) 32" x 60" TUB/SHOWER VERIFY UNIT DIMENSIONS WITH MANUFACTURER PRIOR TO FRAMING
- RECESSED MEDICINE CABINET. PROVIDE 1- HR RATED WALL RECESS WHERE OCCURS IN 1 -HR RATED WALL
- FUTURE 36" GRAB BAR. PROVIDE SOLID BLOCKING CONCEALED WITHIN WALL CENTERED ON BAR LOCATION FUTURE 42" GRAB BAR. PROVIDE SOLID BLOCKING CONCEALED WITHIN WALL CENTERED ON BAR LOCATION
- 4) ELECTRIC PANEL REFER TO ELECTRICAL DRAWINGS FOR SOME INFORMATION POLE AND SHELF. LOCATE POLE 66" ABOVE FINISH FLOOR. PROVIDE 2x6 BLOCKING WITHIN
-) STUD BAY AT EACH END & CENTER OF POLE FOR POLE HARDWARE. VERIFY SHELF BRACKETS & PROVIDE

SCALE

3/16" = 1'-0"

- CEILING MOUNTED HORIZONTAL FAN COIL UNIT. (SEE MECHANICAL PLANS) VERIFY UNIT DIMENSIONS AND CLEARANCE REQUIREMENTS PRIOR TO FRAMING AND SETTING DROPPED CEILING HEIGHT. PROVIDE MINIMUM REQUIRED MANUFACTURE ACCESS PANEL COMPATIBLE WITH F.C.U. PAINT PANEL TO MATCH CEILING.
- METAL THRESHOLD. FLOOR LEVEL CHANGES GREATER THAN 1/4" AT DOORWAYS SHALL BE BEVELED OR SLOP NOT GREATER THAN ONE UNIT VERTICAL IN TWO UNITS HORIZONTAL (50% SLOPE). REFER TO DETAILS AT ENTRY DOOR
- (19) UNIT DOOR BELL AT +48"AFF SEE ELEC
- (20) ACCESSIBLE COMPLIANT LAVATORY
- (21) UNIT SIGNAGE
- (22) WATER SUB METER AT HIGH LEVEL INSIDE CEILING SPACE WITH CEILING ACCESS SEE PLUMBING
- 23) DUAL REMOTE WATER METER DISPLAY. MOUNT HT. AT 4' 0". ABOVE FINISH FLOOR TO TOP OF DISPLAY (24) 15" MIN. BREADBOARD
- 25) ENERGY STAR TANKLESS WATER HEATER. SEE PLUMBING DRAWINGS. VERIFY REQUIRED CLEARANCES WITH MFR PRIOR TO FRAMING
- 26) SMOKE DETECTOR
- (27) CARBON MONOXIDE DETECTOR
- (28) 42" HIGH GUARD RAIL REFER TO EXTERIOR ELEVATIONS. (29) EXTERIOR LOW WALL - REFER TO EXTERIOR ELEVATION
- (30) 1HR RATED SHAFT CONTRACTOR TO VERIFY WITH MECHANICAL DRAWINGS
- (31) EXTERIOR EXHAUST LOUVER SEE MECHANICAL
- (32) GUTTER
- (33) SCUPPER
- (34) CEILING BREAK
- (35) 2" WIDE PVC SOFFIT VENT SEE DETAIL
- (36) NOT USED

SCALE 3/16" = 1'-0"



2173 LOMITA BLVD. #201 LOMITA CALIFORNIA 90717

Architect:

ART ASHAI, AIA

2173 LOMITA BLVD. #201 LOMITA CALIFORNIA 90717 PHONE: 424-263-5888 email: artashai@gmail.com

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MAIN STREET & 21250 21240 MAIN STREE


PROJECT INFORMATION:

21240 Main Street Carson, CA 90745

CARSON APARTMENTS

21250 Main Street Carson, CA 90745 LEGAL DESCRIPTION

APN: 7334-002-007 APN: 7334-002-008

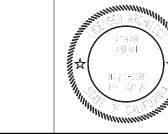


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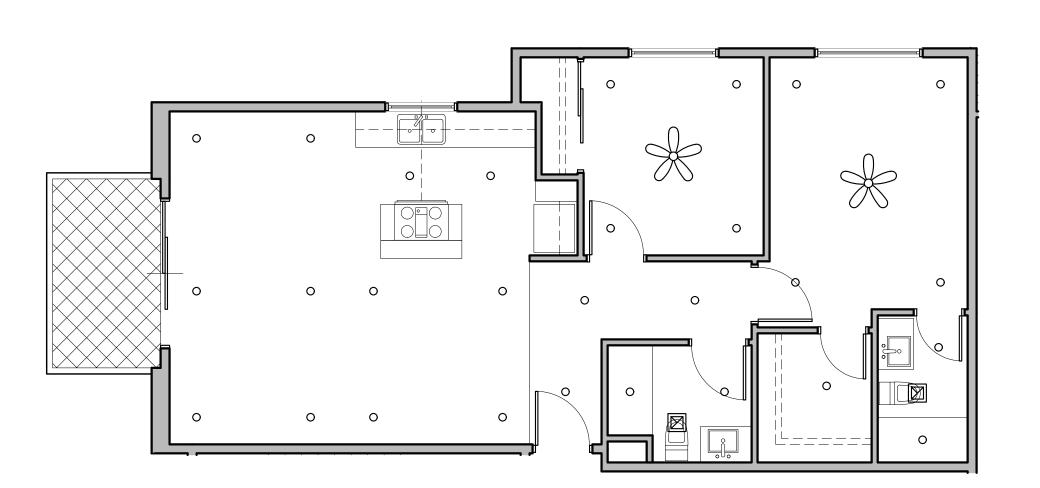
BUILDING B-UNIT PLANS

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Date : Aug2021	Sheet Number :	: 10/20/
Drawn: arkihaus	A-121	DATE
Check'd: CTV/RRJ	/	Ö

UNIT PLAN 201, 301 - FLOOR PLAN


UNIT PLAN 101 - FLOOR PLAN



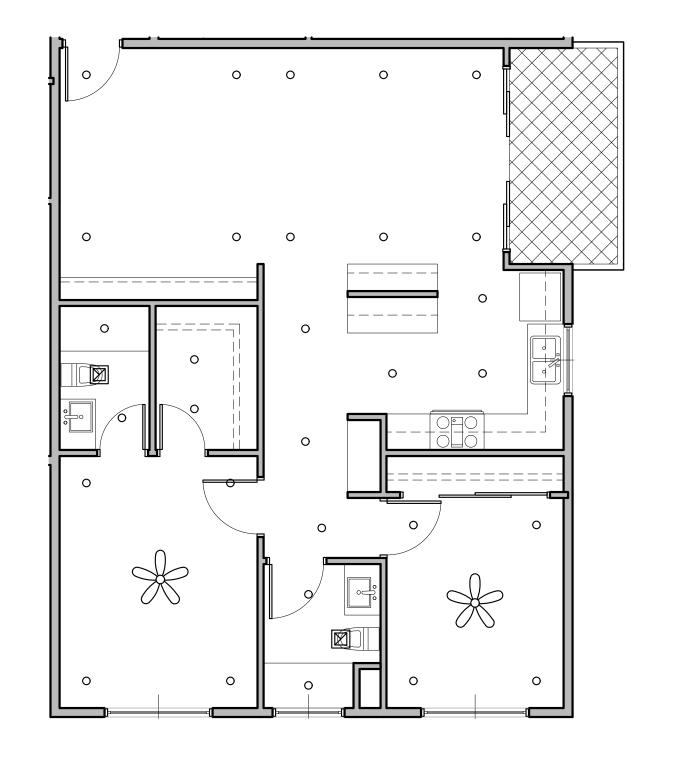


UNIT PLAN 203 - REFLECTED CEILING PLAN

UNIT PLAN 203 - FLOOR PLAN

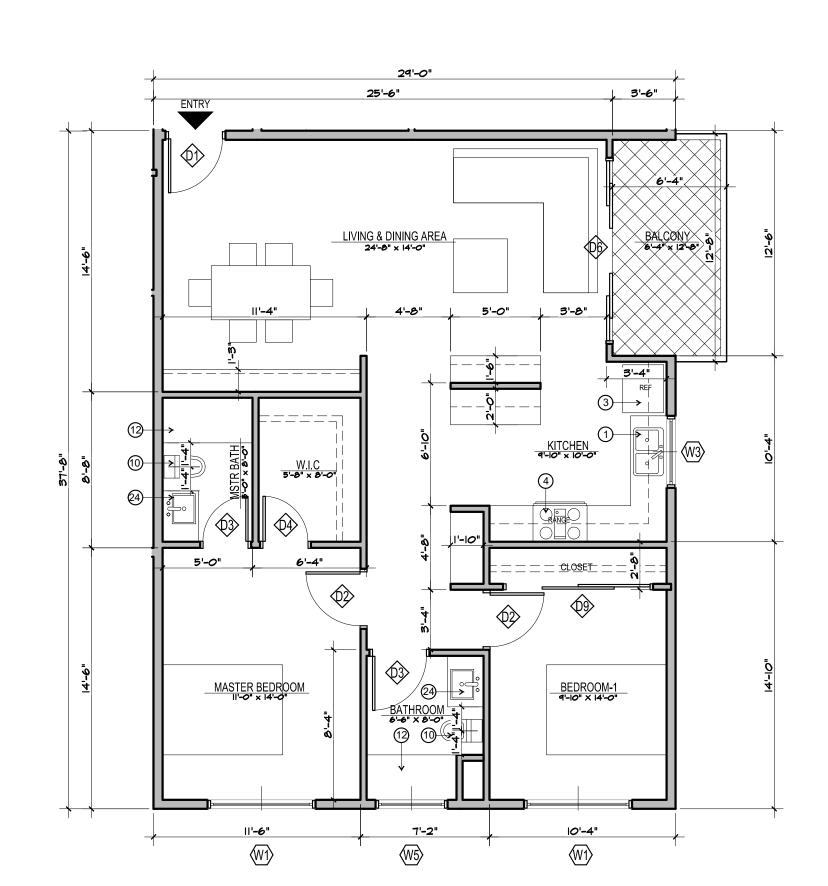

UNIT PLAN 202, 302 - REFLECTED CEILING PLAN

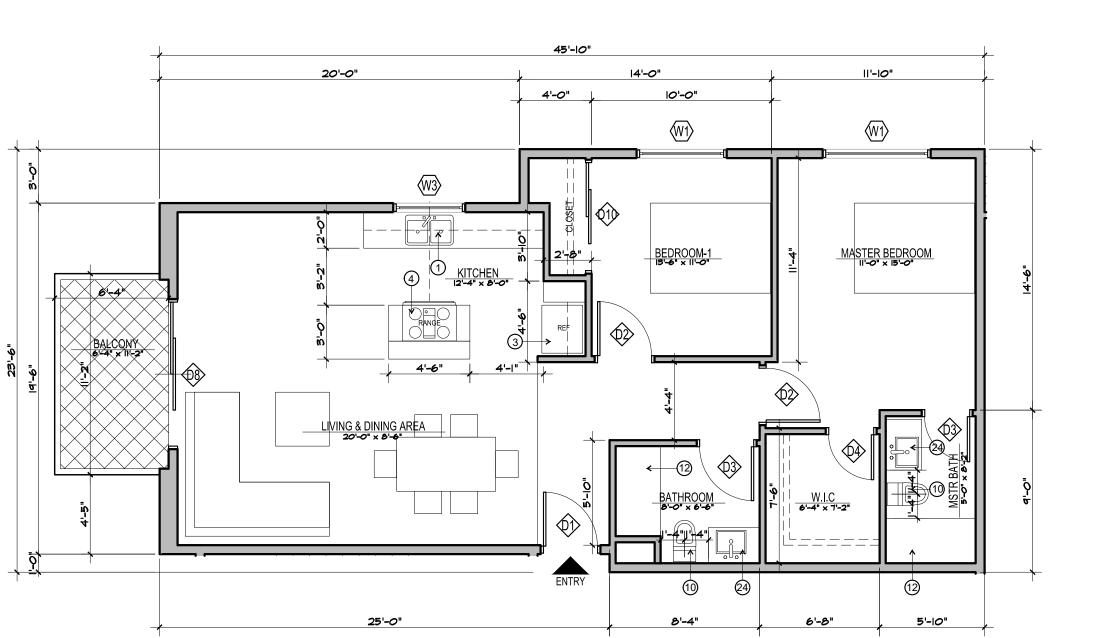

GENERAL NOTES

- DWELLING UNITS ACCESSIBILITY, REFER TO SHEET A-
- COMMON AN PUBLIC AREAS ACCESSIBILITY, REFER TO SHEETS A- AND AALL TUB/SHOWER COMBOS WILL BE UTILIZED FIBERGLASS.
- WALLS ARE PERMITTED TO BE OF NON-RATED CONSTRUCTION EXCEPTS AS GRAPHICALLY NOTED ON BUIL COMPOSITE FLOOR PLANS. UNITS SHALL HAVE AT LEAST A MINIMUM LEAKAGE OF 0.30 CFM50 PER SQUARE FOOT OF ENCLOSURE.
- WATER HEATER UNIT MODEL SEE PLUMBING SCHEDULE. RECESSED LIGHTING SHALL BE "BOXED IN" AT FIRE RATED FLOOR/CLG CONDITIONS DIMENSIONS ARE MEASURED FROM FACE OF STUD (FOS) UNLESS NOTED OTHERWISE.

NIT PL	AN LEGEND
ELEMENT	DESCRIPTION
TYPE A	5/8" GYPSUM BOAR - TAPE, TEXTURE AND PAINT - SATIN LEVEL FIN
TYPE B	5/8" GYPSUM BOAR - TAPE, TEXTURE AND PAINT - SEMI GLOSS LEVEL 4 FIN
TYPE C	EXTERIOR SOFFIT 5/8 " GYP BOARD TYPR X - TAPE, TEXTURE STUCCO FINISH
	LIMIT OF SOFFIT ABOVE - HEIGHT PER FLOOR PLAN. REFER TO DET 14 & 15/A
1 / 2"	FLOOR LEVEL AT DOORS SHALL NOT BE MORE THAN $\frac{1}{2}$ INCH LOWER THAN THRESHOLD AT THE DOORWAY PER C.B.C. SECTION 1008.1.6 AND 1132A. 4.1
HS C	FLOOR MATERIAL FLUSH TRANSITION
$A \bigoplus_{\Delta} A$	INTERIOR ELEVATION KEY
IVING ROOM CARPET 9' - 0"	ROOM NAME — FLOOR FINISH — CEILING HEIGHT
(00)	DOOR NUMBER - REFER TO DOOR SCHEDULE
	WINDOW TYPE - REFER TO WINDOW SCHEDULE
0	RECESSED LIGHT FIXTURE (AT AND IC RATED)
	CEILING FAN
\boxtimes	SUPPLY AIR REGISTER
	SUPPLY AIR SIDE WALL REGISTER
	RETURN AIR REGISTER
	RETURN AIR SIDE WALL REGISTER
	EXHAUST AIR REGISTER / FAN - ENERGY STAR COMPLIANT - SEE MECH
(SD)	SMOKE DETECTOR
<u> </u>	CARBON MONOXIDE DETECTOR

UNIT PLAN KEYNOTES

- DOUBLE BOWL SINK W WITH GARAGE DISPOSAL & HOLE FOR DISHWASHER AIR GAP. PROVIDE ADAPTABLE REQUIREMENTS WHERE NOTED/ REFER TO SCHEDULE OF FINISHES.
- UNDER-COUNTER +/ 24" WIDE DISHWASHER (BOSCH 24" ADA OR APPROVED EQUAL. ENERGY STAR CERTIFIED). PROVIDE ADAPTABLE REQUIREMENTS. REFER TO SCHEDULE OF FINISHES.
- REFRIGERATOR SPACE. PROVIDE COLD WATER STUB-OUT IN RECESSED WALL BOX FOR ICE MAKER. PROVIDE 1-HR RATED WALL RECESS WHERE OCCURS IN 1-HR RATED WALL ASSEMBLY. PROVIDE ADAPTABLE REQUIREMENTS. REFER TO SCHEDULE OF FINISHES.

WALL TYPE SYMBOL. - SEE SCHEDULE ON SHEET A- AND A-

- FREE STANDING RANGE AND OVER THE RANGE MICROWAVE (BOTH ENERGY STAR CERTIFIED) -- VERIFY AND INSTALL APPLIANCES PER MANUFACTURER'S REQUIREMENTS. PROVIDE ADAPTABLE REQUIREMENTS. PROVIDE
- (5) 24" DEEP BASE CABINET WITH COUNTERTOP
- 6) 12" DEEP UPPER CABINET

3/16" = 1'-0"

- 7) ENERGY STAR WASHER AND DRYER STACKED 8 VOID SPACE, FILL IN WITH INSULATION
- (9) ULTRA-LOW FLUSH TOILET REFER TO DETAIL FOR ACCESSIBILITY
- (10) 32" x 60" TUB/SHOWER VERIFY UNIT DIMENSIONS WITH MANUFACTURER PRIOR TO FRAMING
- RECESSED MEDICINE CABINET. PROVIDE 1- HR RATED WALL RECESS WHERE OCCURS IN 1 -HR RATED WALL
- FUTURE 36" GRAB BAR. PROVIDE SOLID BLOCKING CONCEALED WITHIN WALL CENTERED ON BAR LOCATION (13) FUTURE 42" GRAB BAR. PROVIDE SOLID BLOCKING CONCEALED WITHIN WALL CENTERED ON BAR LOCATION
- 14) ELECTRIC PANEL REFER TO ELECTRICAL DRAWINGS FOR SOME INFORMATION
- STUD BAY AT EACH END & CENTER OF POLE FOR POLE HARDWARE. VERIFY SHELF BRACKETS & PROVIDE
- CONCEALED 2x BLOCKING ACCORDINGLY.
 - CEILING MOUNTED HORIZONTAL FAN COIL UNIT. (SEE MECHANICAL PLANS) VERIFY UNIT DIMENSIONS AND CLEARANCE REQUIREMENTS PRIOR TO FRAMING AND SETTING DROPPED CEILING HEIGHT. PROVIDE MINIMUM REQUIRED MANUFACTURE ACCESS PANEL COMPATIBLE WITH F.C.U. PAINT PANEL TO MATCH CEILING.
 - 8 METAL THRESHOLD. FLOOR LEVEL CHANGES GREATER THAN $\frac{1}{4}$ " AT DOORWAYS SHALL BE BEVELED OR SLOPE NOT GREATER THAN ONE UNIT VERTICAL IN TWO UNITS HORIZONTAL (50% SLOPE). REFER TO DETAILS AT ENTRY DOOR AT BALCONY SLIDING DOOR AT ENTRY DOOR AT BALCONY SLIDING DOOR
 - (19) UNIT DOOR BELL AT +48"AFF SEE ELEC
- (20) ACCESSIBLE COMPLIANT LAVATORY
- (21) UNIT SIGNAGE
- (22) WATER SUB METER AT HIGH LEVEL INSIDE CEILING SPACE WITH CEILING ACCESS SEE PLUMBING DUAL REMOTE WATER METER DISPLAY. MOUNT HT. AT 4' - 0". ABOVE FINISH FLOOR TO TOP OF DISPLAY
- (24) 15" MIN. BREADBOARD
- ENERGY STAR TANKLESS WATER HEATER. SEE PLUMBING DRAWINGS. VERIFY REQUIRED CLEARANCES WITH MFR PRIOR TO FRAMING
- (26) SMOKE DETECTOR
- (27) CARBON MONOXIDE DETECTOR
- 28) 42" HIGH GUARD RAIL REFER TO EXTERIOR ELEVATIONS. (29) EXTERIOR LOW WALL - REFER TO EXTERIOR ELEVATION
- (30) 1HR RATED SHAFT CONTRACTOR TO VERIFY WITH MECHANICAL DRAWINGS
- (31) EXTERIOR EXHAUST LOUVER SEE MECHANICAL
- (32) GUTTER
- (33) SCUPPER
- (34) CEILING BREAK
- (35) 2" WIDE PVC SOFFIT VENT SEE DETAIL
- (36) NOT USED

SCALE

3/16" = 1'-0"



2173 LOMITA BLVD. #201 LOMITA CALIFORNIA 90717

Architect:

ART ASHAI, AIA

2173 LOMITA BLVD. #201 LOMITA CALIFORNIA 90717 PHONE: 424-263-5888

email: artashai@gmail.com

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NANCY KIM

MAIN STREET 8 21250 21240 MAIN STREE


PROJECT INFORMATION:

21250 Main Street Carson, CA 90745

CARSON APARTMENTS 21240 Main Street Carson, CA 90745

LEGAL DESCRIPTION

APN: 7334-002-007 APN: 7334-002-008

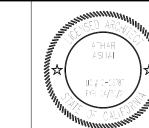

Rev.#	Date/Issue	Notes	
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BUILDING B-UNIT PLANS

AS NOTED J-1908 Date: Aug2021 Sheet Number: Drawn: arkihaus Check'd: CTV/RRJ

UNIT PLAN 202, 302 - FLOOR PLAN



GENERAL NOTES

- DWELLING UNITS ACCESSIBILITY, REFER TO SHEET A-
- COMMON AN PUBLIC AREAS ACCESSIBILITY, REFER TO SHEETS A- AND A-
- ALL TUB/SHOWER COMBOS WILL BE UTILIZED FIBERGLASS.
 WALLS ARE PERMITTED TO BE OF NON-RATED CONSTRUCTION EXCEPTS AS GRAPHICALLY NOTED ON BUIL
- COMPOSITE FLOOR PLANS. 5. UNITS SHALL HAVE AT LEAST A MINIMUM LEAKAGE OF 0.30 CFM50 PER SQUARE FOOT OF ENCLOSURE.
- 6. WATER HEATER UNIT MODEL SEE PLUMBING SCHEDULE. RECESSED LIGHTING SHALL BE "BOXED IN" AT FIRE RATED FLOOR/CLG CONDITIONS 8. DIMENSIONS ARE MEASURED FROM FACE OF STUD (FOS) UNLESS NOTED OTHERWISE.

NIT PL	AN LEGEND	
ELEMENT	DESCRIPTION	
YPE A	5/8" GYPSUM BOAR - TAPE, TEXTURE AND PAINT - SATIN LEVEL FIN	2 1 7 3 LOMITA BLVD. # 2 0 1
ТҮРЕ В	5/8" GYPSUM BOAR - TAPE, TEXTURE AND PAINT - SEMI GLOSS LEVEL 4 FIN	LOMITA CALIFORNIA 90717
YPE C	EXTERIOR SOFFIT 5/8 " GYP BOARD TYPR X - TAPE, TEXTURE STUCCO FINISH	Architect:
	LIMIT OF SOFFIT ABOVE - HEIGHT PER FLOOR PLAN. REFER TO DET 14 & 15/A-	Ardinect.
1 / 2"	FLOOR LEVEL AT DOORS SHALL NOT BE MORE THAN $\frac{1}{2}$ INCH LOWER THAN THRESHOLD AT THE DOORWAY PER C.B.C. SECTION 1008.1.6 AND 1132A. 4.1	ART ASHAI, AIA
HS C	FLOOR MATERIAL FLUSH TRANSITION	2173 LOMITA BLVD. #201
Å A	INTERIOR ELEVATION KEY	LOMITA CALIFORNIA 90717 PHONE: 424-263-5888
ING ROOM CARPET 9'-0"	ROOM NAME FLOOR FINISH CEILING HEIGHT	email: artashai@gmail.com
00	DOOR NUMBER - REFER TO DOOR SCHEDULE	
	WINDOW TYPE - REFER TO WINDOW SCHEDULE	Copyright:
0	RECESSED LIGHT FIXTURE (AT AND IC RATED)	This drawing is the property of DESIGNER, and it is not to be reproduced or copied in whole or
H	CEILING FAN	part. It is not to be used for any other project and is to be returned upon request. The DESIGNER retains all copyrights for this document.
\boxtimes	SUPPLY AIR REGISTER	Owner:
 →→	SUPPLY AIR SIDE WALL REGISTER	NANCY KIM
	RETURN AIR REGISTER	-
	RETURN AIR SIDE WALL REGISTER	
	EXHAUST AIR REGISTER / FAN - ENERGY STAR COMPLIANT - SEE MECH	
(SD)	SMOKE DETECTOR	
<u>©</u>	CARBON MONOXIDE DETECTOR	
(WA)	WALL TYPE SYMBOL SEE SCHEDULE ON SHEET A AND A	

UNIT PLAN KEYNOTES

- DOUBLE BOWL SINK W WITH GARAGE DISPOSAL & HOLE FOR DISHWASHER AIR GAP. PROVIDE ADAPTABLE REQUIREMENTS WHERE NOTED/ REFER TO SCHEDULE OF FINISHES.
- UNDER-COUNTER +/ 24" WIDE DISHWASHER (BOSCH 24" ADA OR APPROVED EQUAL. ENERGY STAR CERTIFIED). PROVIDE ADAPTABLE REQUIREMENTS. REFER TO SCHEDULE OF FINISHES.
- REFRIGERATOR SPACE. PROVIDE COLD WATER STUB-OUT IN RECESSED WALL BOX FOR ICE MAKER. PROVIDE
- 1-HR RATED WALL RECESS WHERE OCCURS IN 1-HR RATED WALL ASSEMBLY. PROVIDE ADAPTABLE REQUIREMENTS. REFER TO SCHEDULE OF FINISHES.

FREE STANDING RANGE AND OVER THE RANGE MICROWAVE (BOTH ENERGY STAR CERTIFIED) - VERIFY AND INSTALL APPLIANCES PER MANUFACTURER'S REQUIREMENTS. PROVIDE ADAPTABLE REQUIREMENTS. PROVIDE

- 5 24" DEEP BASE CABINET WITH COUNTERTOP 6 12" DEEP UPPER CABINET
- (7) ENERGY STAR WASHER AND DRYER -- STACKED
- (8) VOID SPACE, FILL IN WITH INSULATION 9 ULTRA-LOW FLUSH TOILET - REFER TO DETAIL FOR ACCESSIBILITY REQUIREMENTS
- (10) 32" x 60" TUB/SHOWER VERIFY UNIT DIMENSIONS WITH MANUFACTURER
- PRIOR TO FRAMING RECESSED MEDICINE CABINET. PROVIDE 1- HR RATED WALL RECESS WHERE OCCURS IN 1-HR RATED WALL
- FUTURE 36" GRAB BAR. PROVIDE SOLID BLOCKING CONCEALED WITHIN WALL CENTERED ON BAR LOCATION
- FUTURE 42" GRAB BAR. PROVIDE SOLID BLOCKING CONCEALED WITHIN WALL CENTERED ON BAR LOCATION
- (14) ELECTRIC PANEL REFER TO ELECTRICAL DRAWINGS FOR SOME INFORMATION POLE AND SHELF. LOCATE POLE 66" ABOVE FINISH FLOOR. PROVIDE 2x6 BLOCKING WITHIN
- 5) STUD BAY AT EACH END & CENTER OF POLE FOR POLE HARDWARE. VERIFY SHELF BRACKETS & PROVIDE CONCEALED 2x BLOCKING ACCORDINGLY.

- 7) CEILING MOUNTED HORIZONTAL FAN COIL UNIT. (SEE MECHANICAL PLANS) VERIFY UNIT DIMENSIONS AND CLEARANCE REQUIREMENTS PRIOR TO FRAMING AND SETTING DROPPED CEILING HEIGHT. PROVIDE MINIMUM
- REQUIRED MANUFACTURE ACCESS PANEL COMPATIBLE WITH F.C.U. PAINT PANEL TO MATCH CEILING. 18) METAL THRESHOLD. FLOOR LEVEL CHANGES GREATER THAN 4" AT DOORWAYS SHALL BE BEVELED OR SLOPE NOT GREATER THAN ONE UNIT VERTICAL IN TWO UNITS
 HORIZONTAL (50% SLOPE). REFER TO DETAILS AT ENTRY DOOR AT BALCONY SLIDING DOOR
- (19) UNIT DOOR BELL AT +48"AFF SEE ELEC
- (20) ACCESSIBLE COMPLIANT LAVATORY
- (21) UNIT SIGNAGE
- (22) WATER SUB METER AT HIGH LEVEL INSIDE CEILING SPACE WITH CEILING ACCESS SEE PLUMBING (23) DUAL REMOTE WATER METER DISPLAY. MOUNT HT. AT 4' - 0". ABOVE FINISH FLOOR TO TOP OF DISPLAY
- (24) 15" MIN. BREADBOARD
- (25) ENERGY STAR TANKLESS WATER HEATER. SEE PLUMBING DRAWINGS.
- (26) SMOKE DETECTOR
- (27) CARBON MONOXIDE DETECTOR
- (28) 42" HIGH GUARD RAIL REFER TO EXTERIOR ELEVATIONS.
- (29) EXTERIOR LOW WALL REFER TO EXTERIOR ELEVATION (30) 1HR RATED SHAFT - CONTRACTOR TO VERIFY WITH MECHANICAL DRAWINGS
- (31) EXTERIOR EXHAUST LOUVER SEE MECHANICAL
- 32) GUTTER
- 33) SCUPPER
- (34) CEILING BREAK
- (35) 2" WIDE PVC SOFFIT VENT SEE DETAIL
- (36) NOT USED



MAIN STREET & 21250 21240 MAIN STREE

PROJECT INFORMATION:


21240 Main Street Carson, CA 90745

21250 Main Street Carson, CA 90745

CARSON APARTMENTS

LEGAL DESCRIPTION


APN: 7334-002-007 APN: 7334-002-008

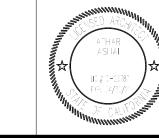


Rev.#	Date/Issue	Notes	
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Sheet Title: **BUILDING B-UNIT PLANS**

AS NOTED J-1908 Date: Aug2021 Sheet Number: Drawn: arkihaus Check'd: CTV/RRJ



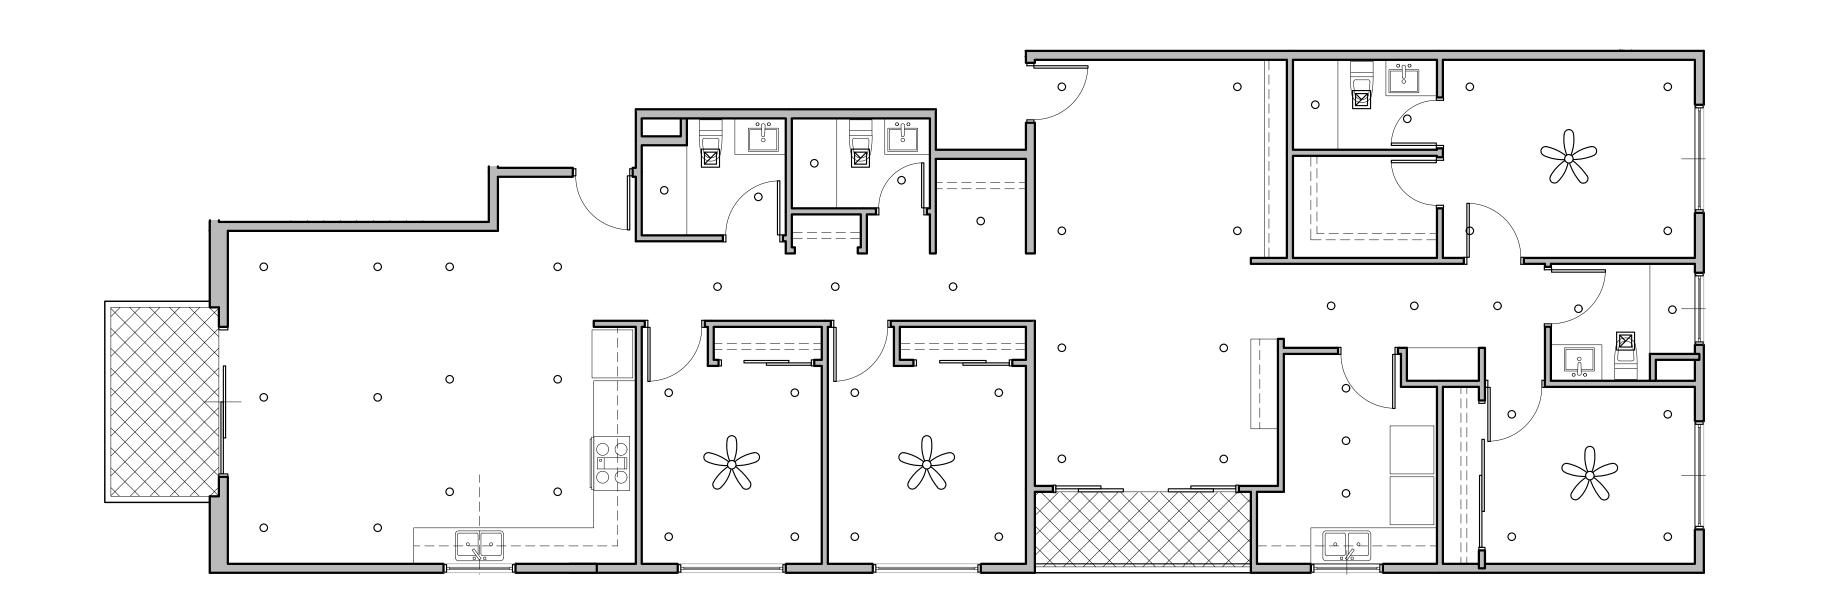

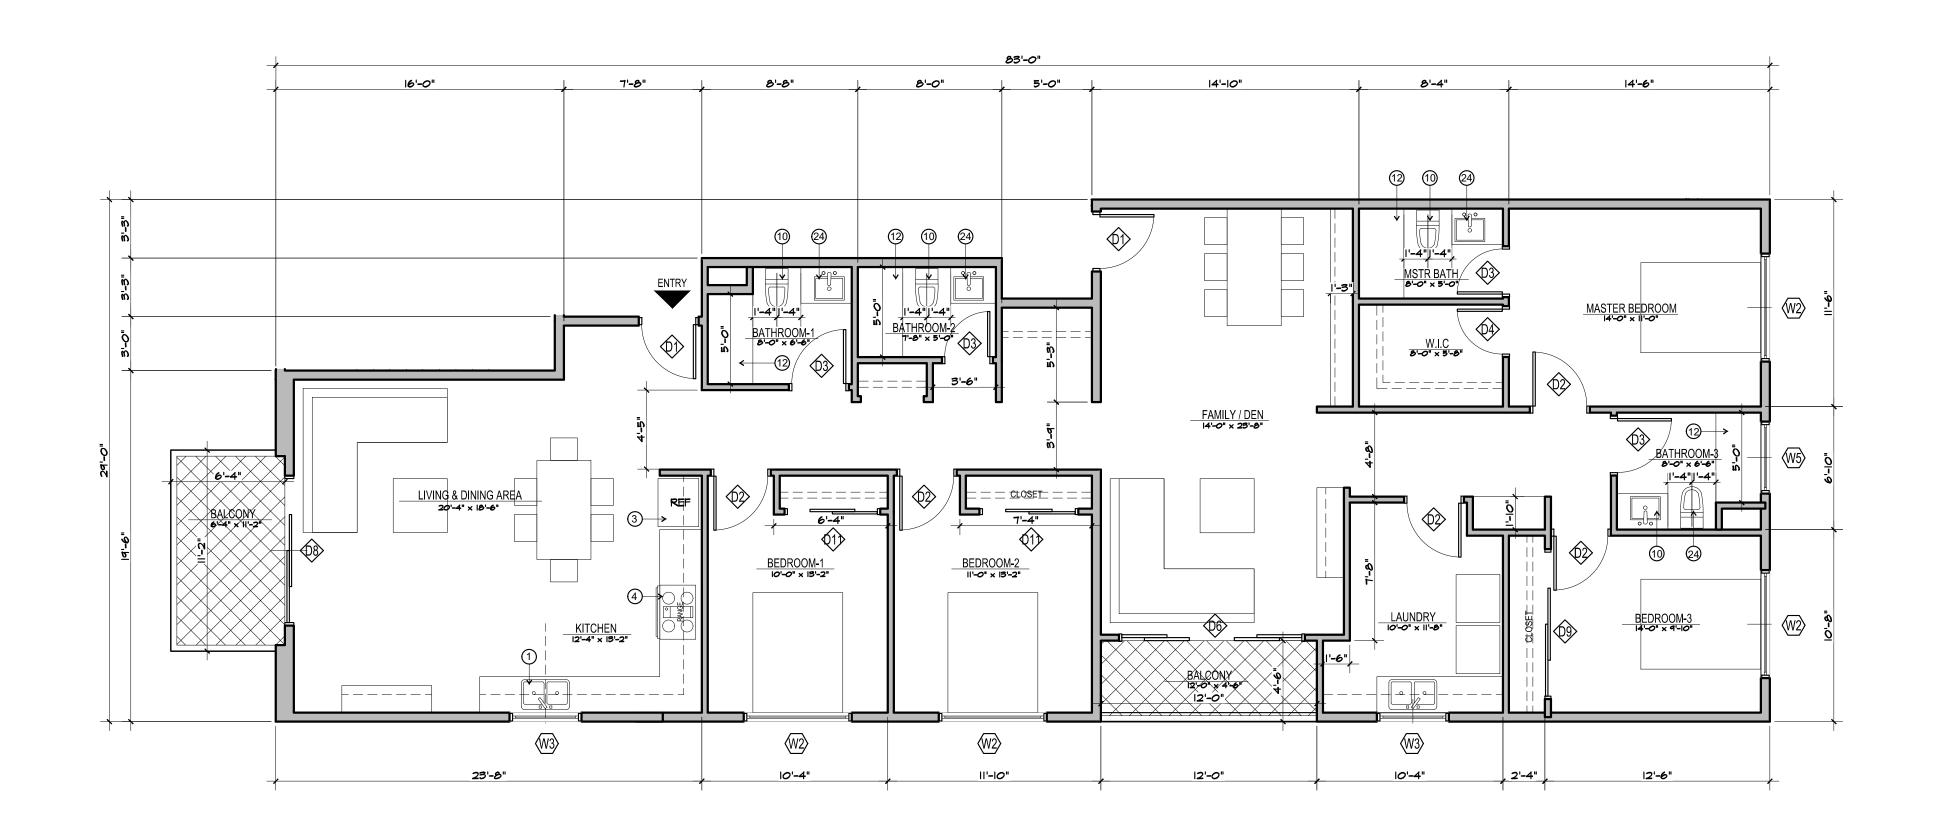

GENERAL NOTES

- DWELLING UNITS ACCESSIBILITY, REFER TO SHEET A-
- COMMON AN PUBLIC AREAS ACCESSIBILITY, REFER TO SHEETS A- AND A-
- 3. ALL TUB/SHOWER COMBOS WILL BE UTILIZED FIBERGLASS. . WALLS ARE PERMITTED TO BE OF NON-RATED CONSTRUCTION EXCEPTS AS GRAPHICALLY NOTED ON BUI
- COMPOSITE FLOOR PLANS.

 5. UNITS SHALL HAVE AT LEAST A MINIMUM LEAKAGE OF 0.30 CFM50 PER SQUARE FOOT OF ENCLOSURE.

 6. WATER HEATER UNIT MODEL SEE PLUMBING SCHEDULE.
- RECESSED LIGHTING SHALL BE "BOXED IN" AT FIRE RATED FLOOR/CLG CONDITIONS 8. DIMENSIONS ARE MEASURED FROM FACE OF STUD (FOS) UNLESS NOTED OTHERWISE.

LIMIT DI ANTI ECEND

ELEMENT	DESCRIPTION
TYPE A	5/8" GYPSUM BOAR - TAPE, TEXTURE AND PAINT - SATIN LEVEL FIN
TYPE B	5/8" GYPSUM BOAR - TAPE, TEXTURE AND PAINT - SEMI GLOSS LEVEL 4 FIN
TYPE C	EXTERIOR SOFFIT 5/8 " GYP BOARD TYPR X - TAPE, TEXTURE STUCCO FINISH
	LIMIT OF SOFFIT ABOVE - HEIGHT PER FLOOR PLAN. REFER TO DET 14 & 15/A-
1/2"	FLOOR LEVEL AT DOORS SHALL NOT BE MORE THAN ½ INCH LOWER THAN THRESHOLD AT THE DOORWAY PER C.B.C. SECTION 1008.1.6 AND 1132A. 4.1
HS C	FLOOR MATERIAL FLUSH TRANSITION
A Â A	INTERIOR ELEVATION KEY
IVING ROOM — CARPET —	ROOM NAME FLOOR FINISH
9' - 0"	CEILING HEIGHT
00	DOOR NUMBER - REFER TO DOOR SCHEDULE
200	WINDOW TYPE - REFER TO WINDOW SCHEDULE
0	RECESSED LIGHT FIXTURE (AT AND IC RATED)
	CEILING FAN
	SUPPLY AIR REGISTER
] →→	SUPPLY AIR SIDE WALL REGISTER
	RETURN AIR REGISTER
	RETURN AIR SIDE WALL REGISTER
	EXHAUST AIR REGISTER / FAN - ENERGY STAR COMPLIANT - SEE MECH
SD	SMOKE DETECTOR
©	CARBON MONOXIDE DETECTOR
	WALL TYPE OWNER, OFF COLIFFIES ON CUEFT A AND A

UNIT PLAN KEYNOTES

- DOUBLE BOWL SINK W WITH GARAGE DISPOSAL & HOLE FOR DISHWASHER AIR GAP. PROVIDE ADAPTABLE REQUIREMENTS WHERE NOTED/REFER TO SCHEDULE OF FINISHES.
- UNDER-COUNTER +/ 24" WIDE DISHWASHER (BOSCH 24" ADA OR APPROVED EQUAL. ENERGY STAR CERTIFIED). PROVIDE ADAPTABLE REQUIREMENTS.
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WALL TYPE SYMBOL. - SEE SCHEDULE ON SHEET A-- AND A--

- FREE STANDING RANGE AND OVER THE RANGE MICROWAVE (BOTH ENERGY STAR CERTIFIED) VERIFY AND INSTALL APPLIANCES PER MANUFACTURER'S REQUIREMENTS. PROVIDE ADAPTABLE REQUIREMENTS. PROVIDE
- (5) 24" DEEP BASE CABINET WITH COUNTERTOP
- 6 12" DEEP UPPER CABINET 7) ENERGY STAR WASHER AND DRYER -- STACKED
- 8 VOID SPACE, FILL IN WITH INSULATION
- 9 ULTRA-LOW FLUSH TOILET REFER TO DETAIL FOR ACCESSIBILITY REQUIREMENTS
- (10) 32" x 60" TUB/SHOWER VERIFY UNIT DIMENSIONS WITH MANUFACTURER
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- 19 UNIT DOOR BELL AT +48"AFF SEE ELEC (20) ACCESSIBLE COMPLIANT LAVATORY
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- (28) 42" HIGH GUARD RAIL REFER TO EXTERIOR ELEVATIONS.
- 29 EXTERIOR LOW WALL REFER TO EXTERIOR ELEVATION
- (30) 1HR RATED SHAFT CONTRACTOR TO VERIFY WITH MECHANICAL DRAWINGS (31) EXTERIOR EXHAUST LOUVER - SEE MECHANICAL
- 32) GUTTER

SCALE 3/16" = 1'-0"

- (33) SCUPPER
- (34) CEILING BREAK
- (35) 2" WIDE PVC SOFFIT VENT SEE DETAIL
- (36) NOT USED



2173 LOMITA BLVD. #201 LOMITA CALIFORNIA 90717

Architect:

ART ASHAI, AIA

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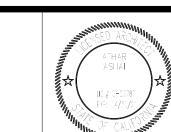
PROJECT INFORMATION:

21250 Main Street Carson, CA 90745

CARSON APARTMENTS 21240 Main Street Carson, CA 90745

LEGAL DESCRIPTION APN: 7334-002-007

APN: 7334-002-008



Rev.#	Date/Issue	Notes	
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BUILDING B-UNIT PLANS

Scale : AS NOTED	Job Number : J-1908	0/21
Date: Aug2021	Sheet Number :	: 10/2
Drawn: arkihaus	A-124	DATE
Check'd: CTV/RRJ		O

UNIT PLAN 303 - FLOOR PLAN



21250 Main Street Carson, CA 90745 LEGAL DESCRIPTION APN: 7334-002-007 APN: 7334-002-008 Sheet Title: AS NOTED Date: Aug2021 Drawn: arkihaus Check'd: CTV/RRJ

DESIGN STUDIO

2 1 7 3 LOMITA BLVD. # 2 0 1 LOMITA CALIFORNIA 9 0 7 1 7

Architect:

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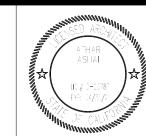
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21240 MAIN STREET & 21250 MAIN STREET

PROJECT INFORMATION:

Project Title: CARSON APARTMENTS 21240 Main Street Carson, CA 90745



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ELEVATIONS

Job Number : J-1908 Sheet Number:

2173 LOMITA BLVD. #201 LOMITA CALIFORNIA 90717

Architect:

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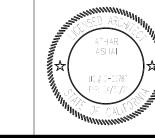
CARSON LOFTS
21240 MAIN STREET & 21250 MAIN STREET

PROJECT INFORMATION:

Project Title : CARSON A

CARSON APARTMENTS 21240 Main Street Carson, CA 90745 21250 Main Street Carson, CA 90745

LEGAL DESCRIPTION APN: 7334-002-007 APN: 7334-002-008



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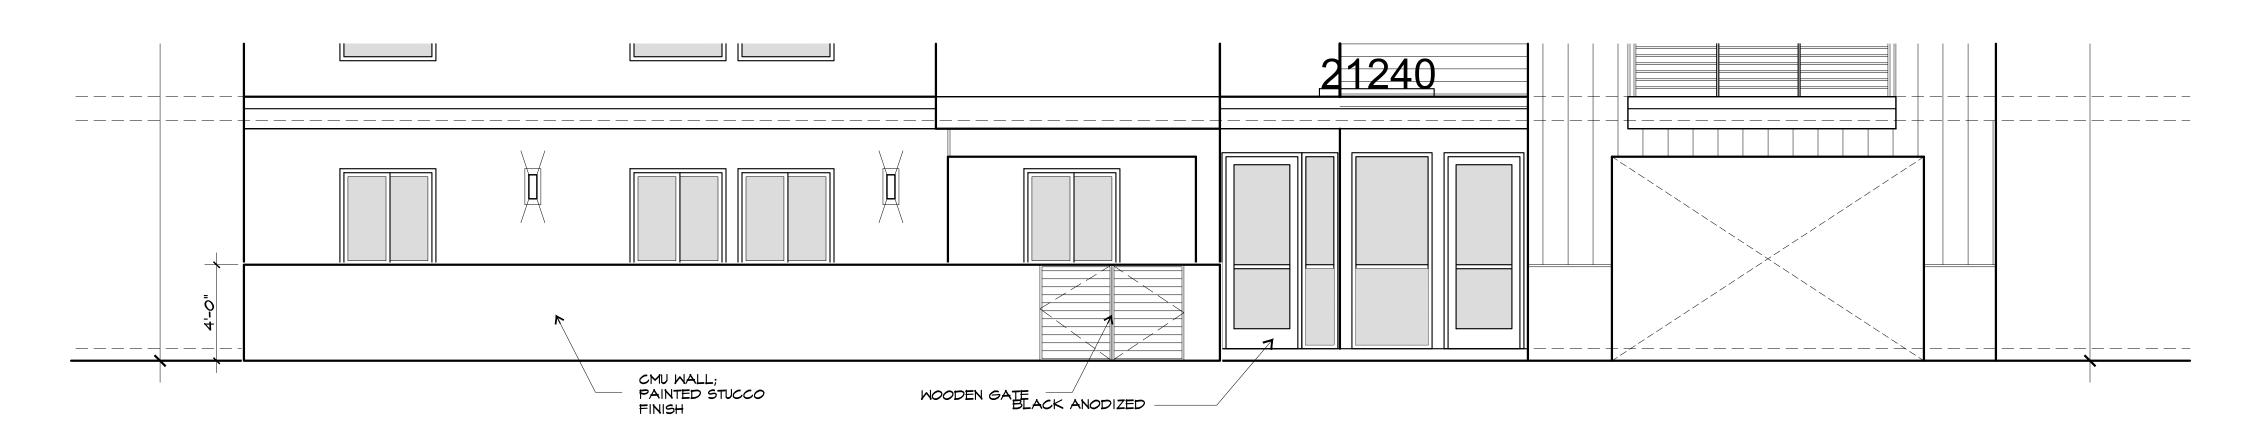
BLOW-UP ELEVATIONS

Scale : AS NOTED	Job Number : J-1908
Date: May 2021	Sheet Number :
Drawn: arkihaus	A-201.1
Check'd: CTV/RRJ	

BLOWLIP FLEVATION (21250 MAIN STREET)


2 BLOW-UP ELEVATION (21250 MAIN STREET)

SCALE: 1/4" = 1'-0"



BLOW-UP ELEVATION (21240 MAIN STREET)

SCALE: 1/4" = 1'-0"

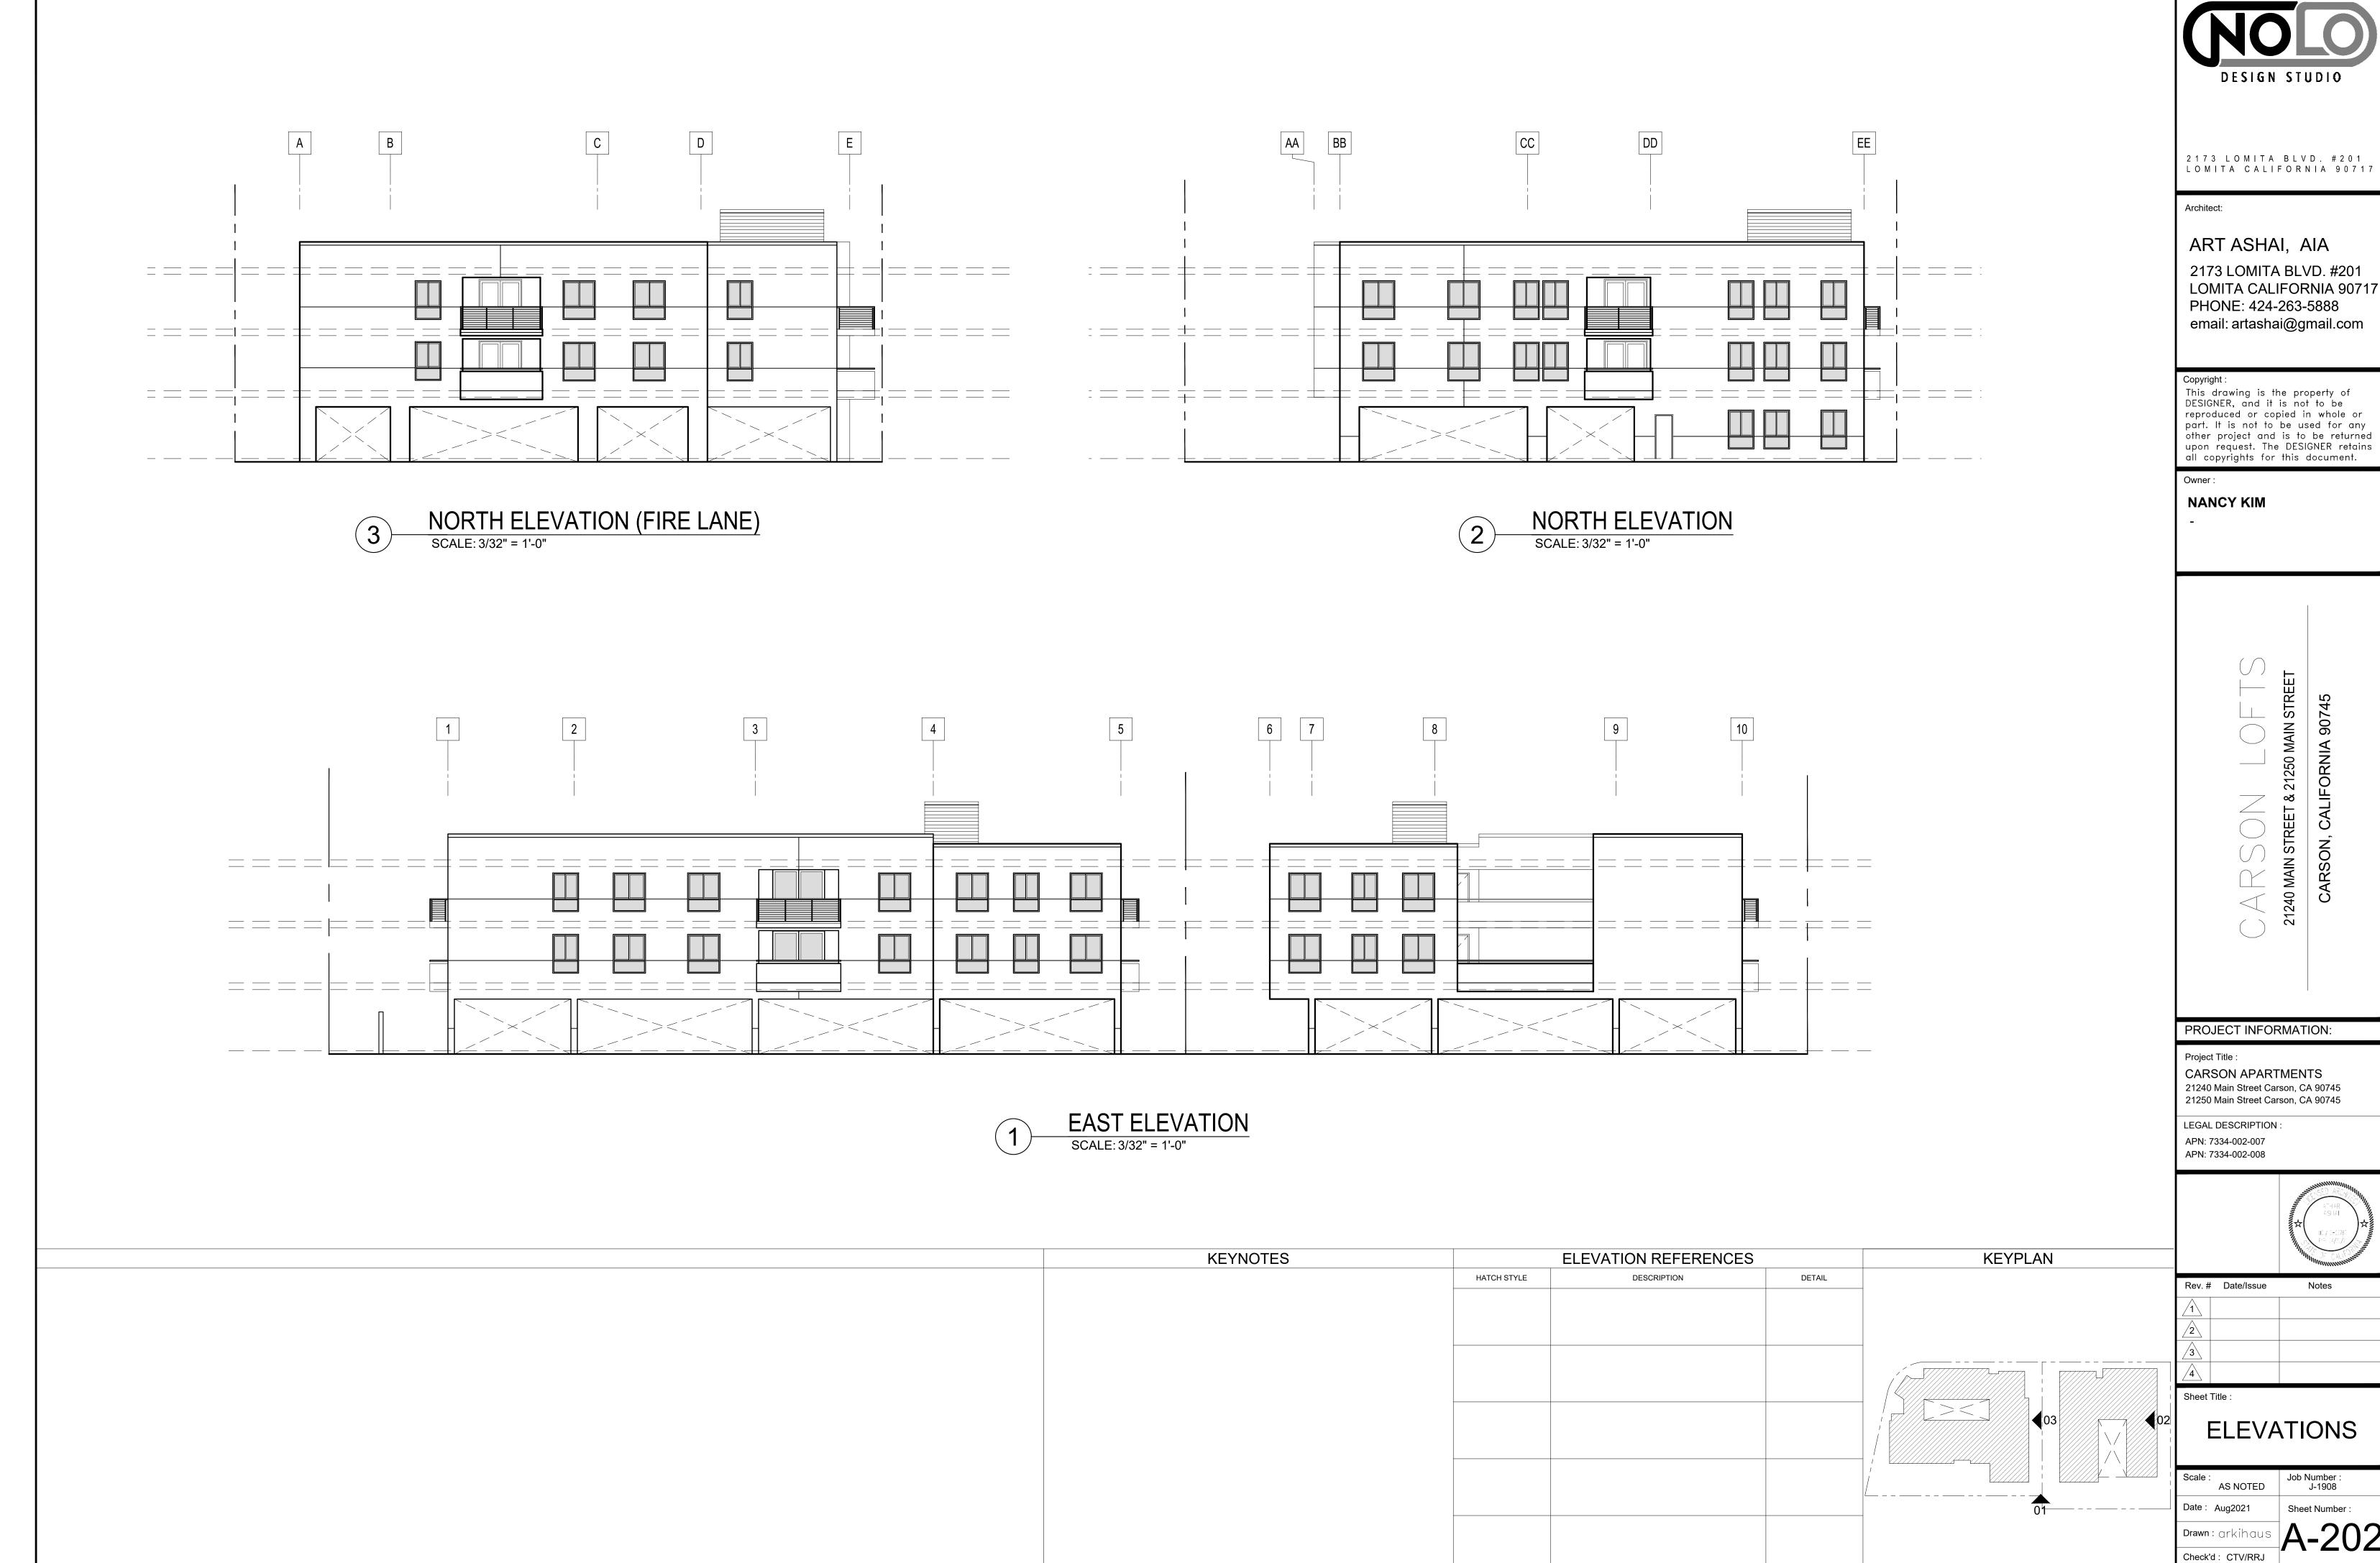




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ELEVATIONS

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Date : Aug2021	Sheet Number :	: 10/20/2
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2 1 7 3 L O M I T A B L V D . # 2 0 1 L O M I T A C A L I F O R N I A 9 0 7 1 7

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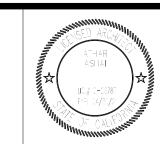


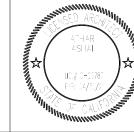

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RENDERINGS


AS NOTED	J-1908
Date: Aug2021	Sheet Number :
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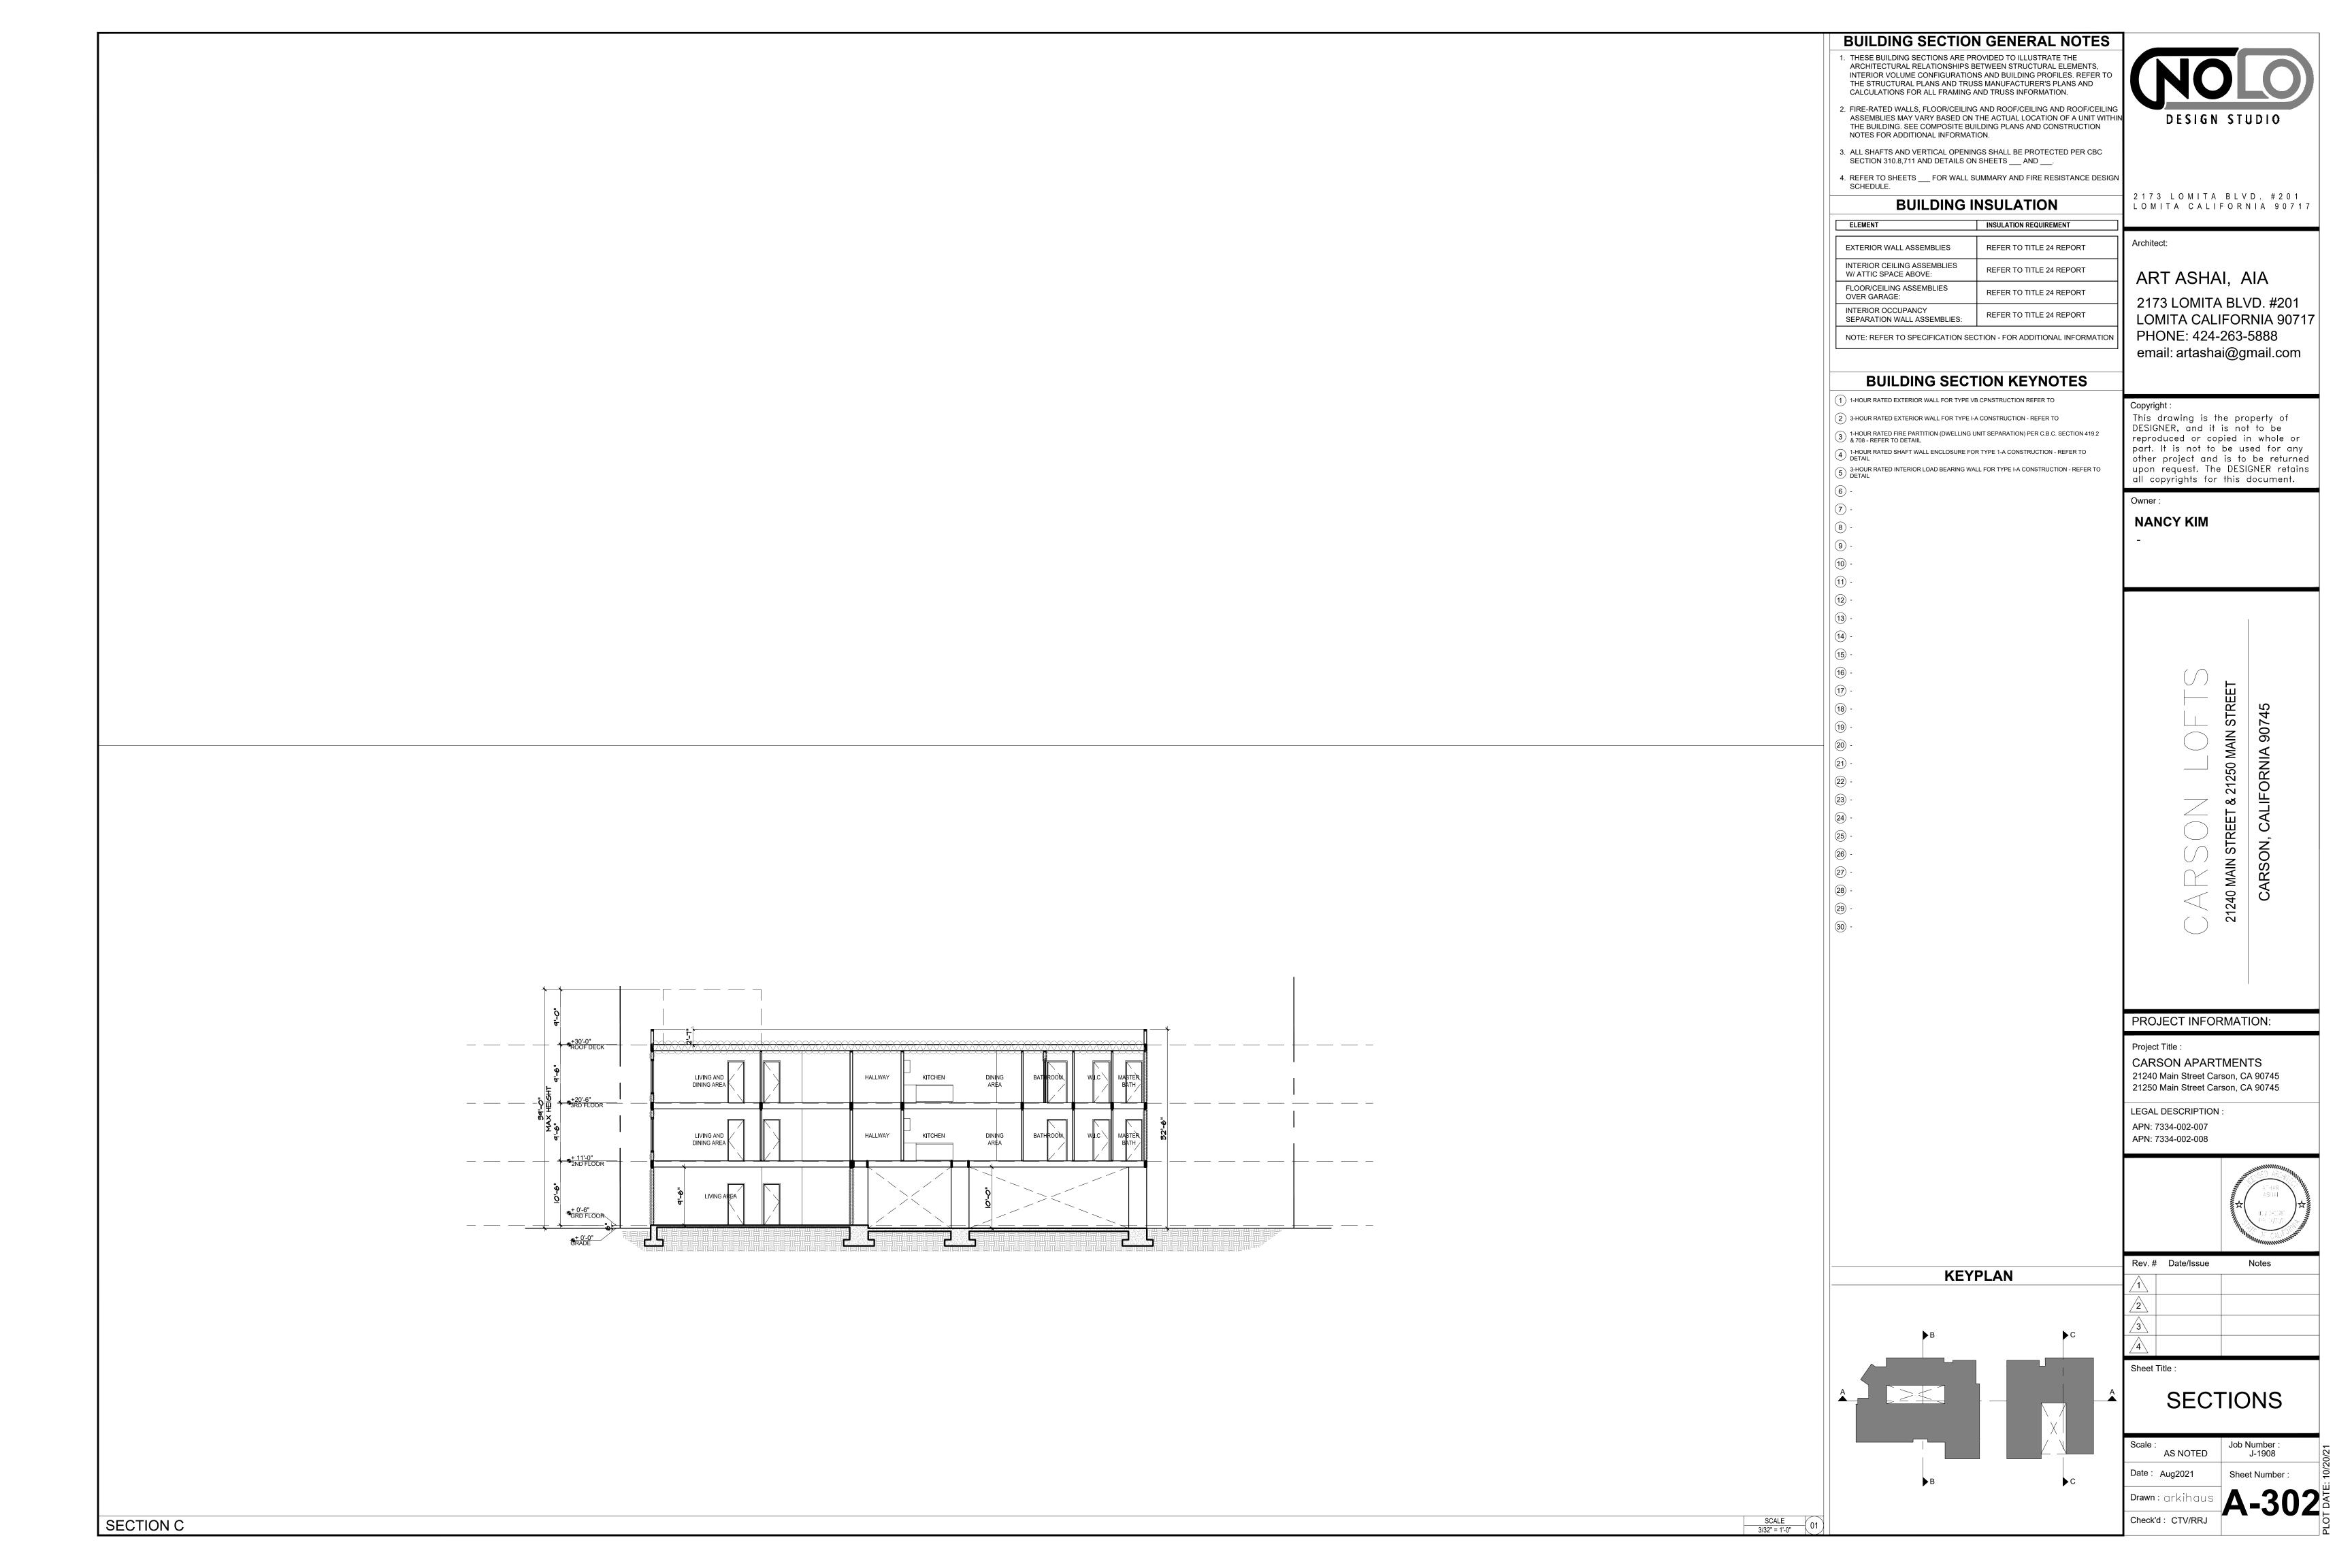




SOUTHWEST RENDERING

NORTHWEST RENDERING



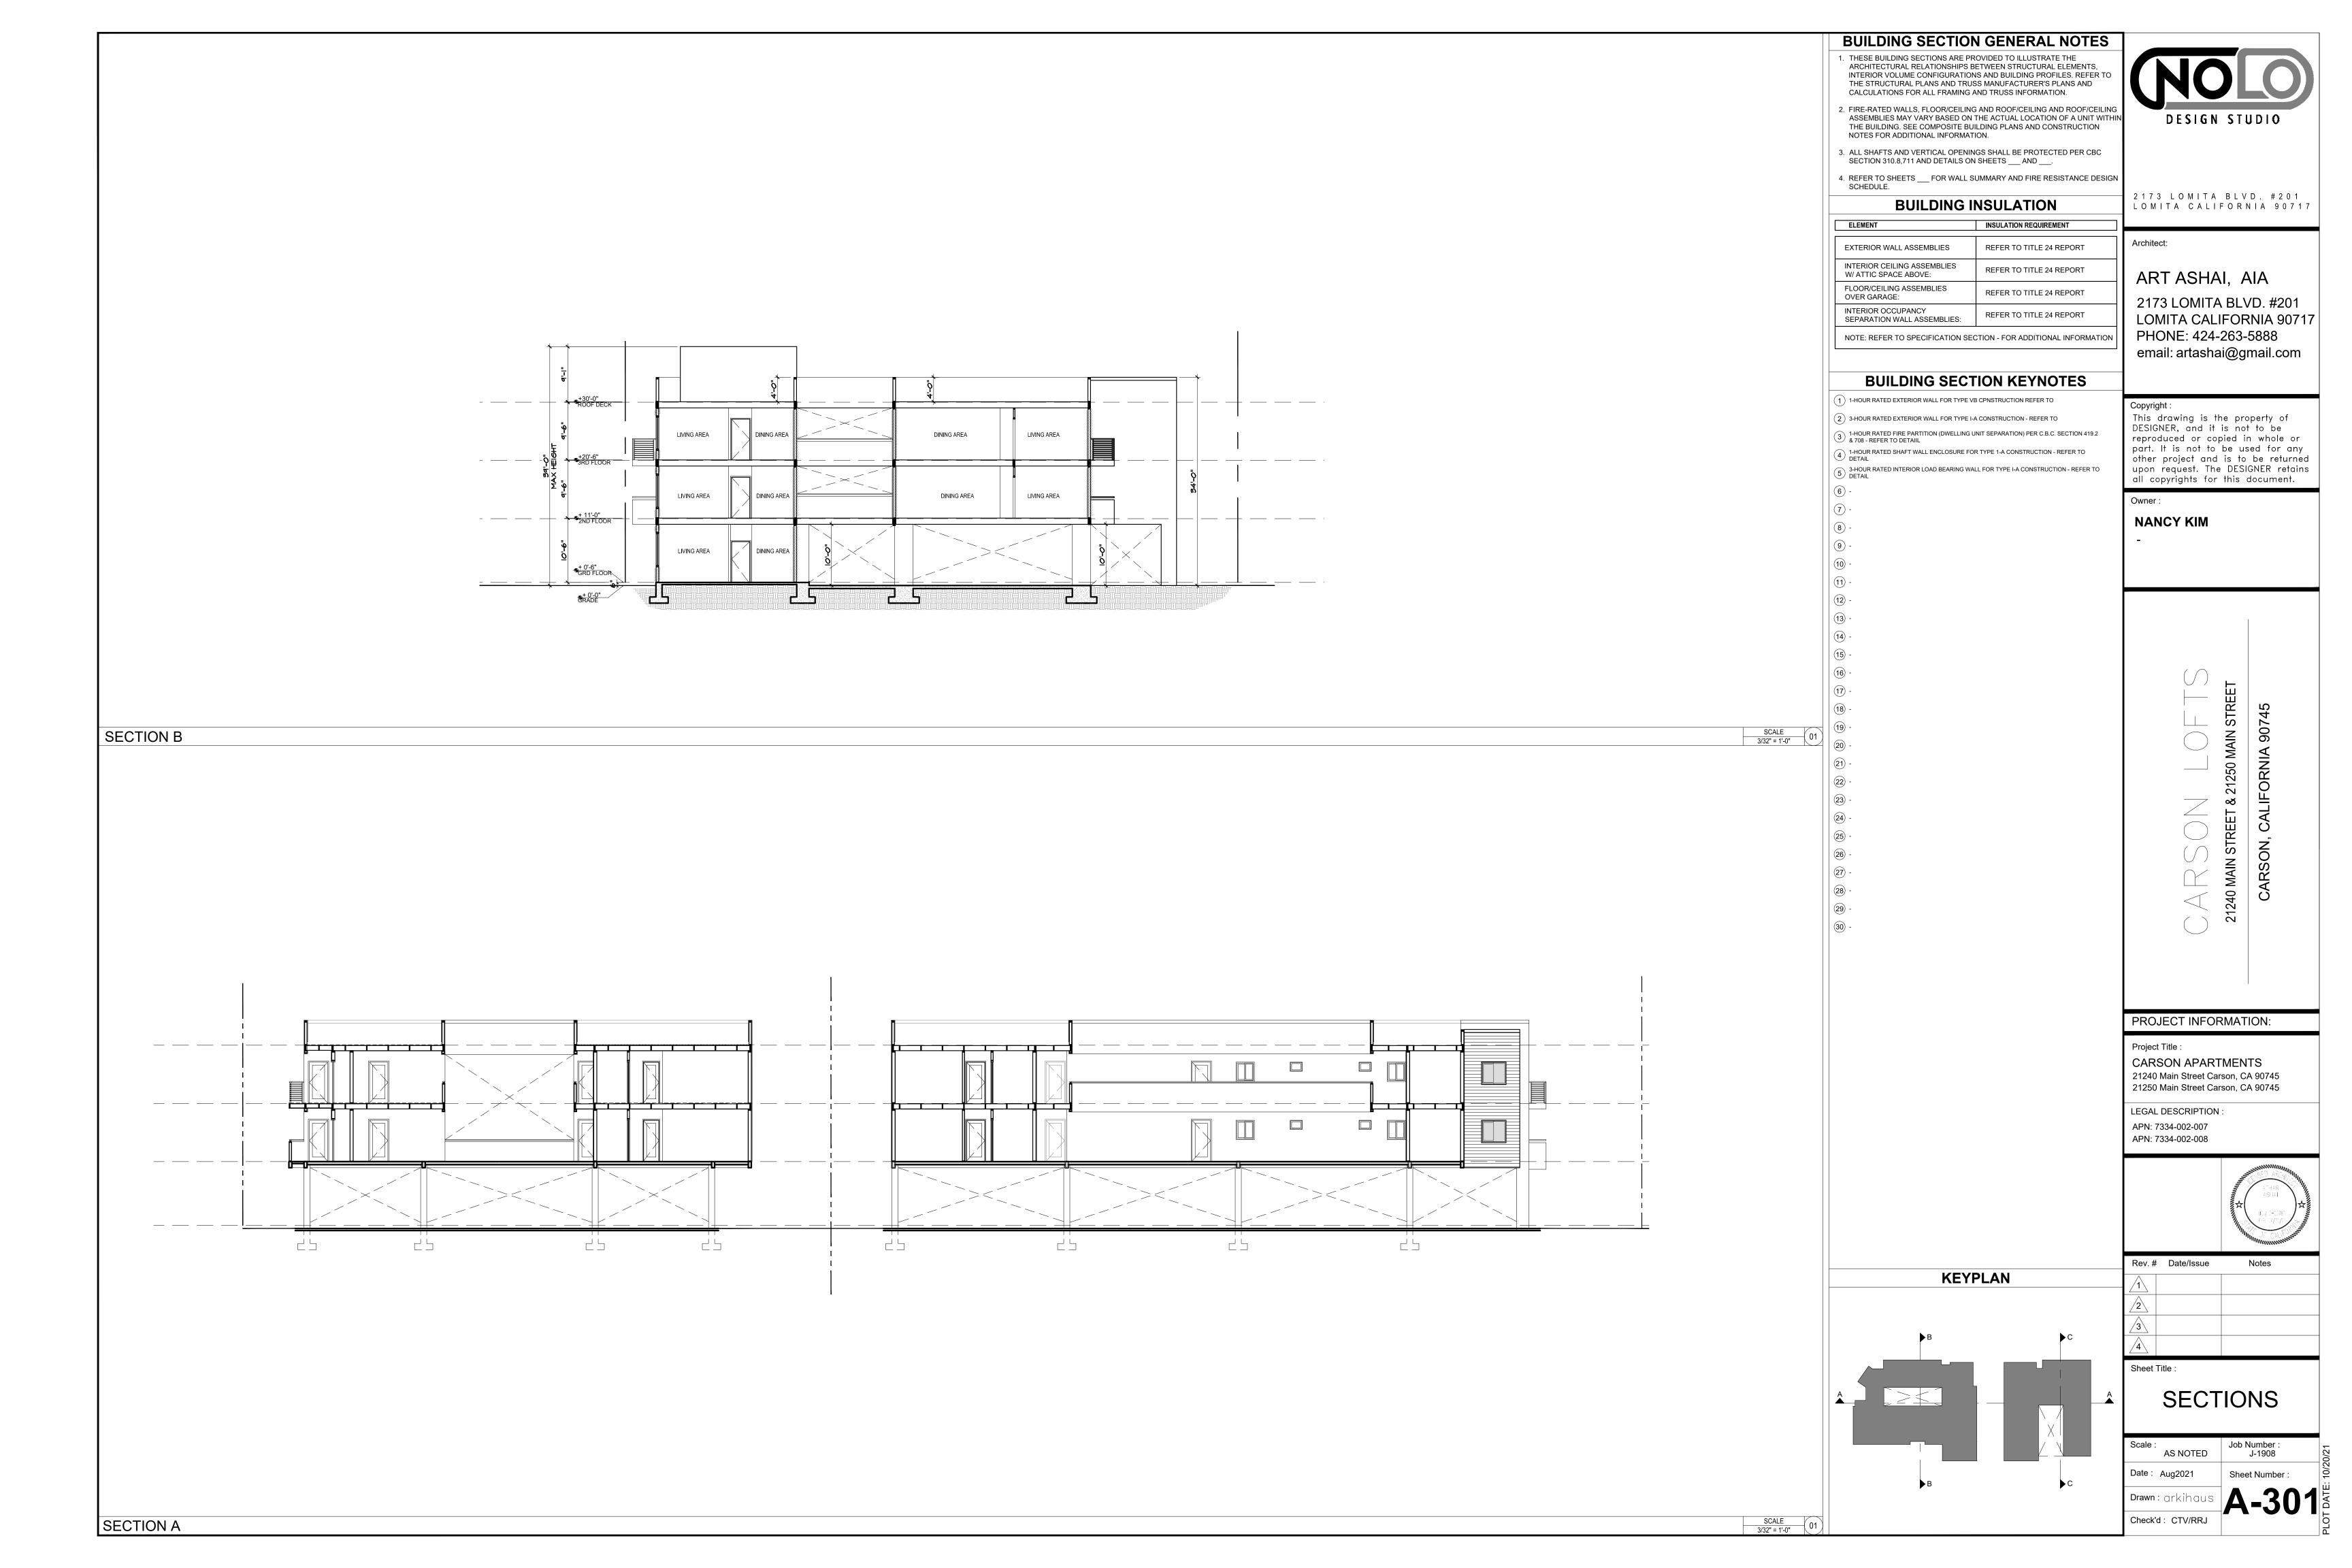

GENERAL NOTES:

- 1. ALL GRADING AND CONSTRUCTION SHALL CONFORM TO APPENDIX CHAPTER 33 AND CHAPTER 71 (LATEST EDITION) OF THE LOS ANGELES COUNTY BUILDING CODE UNLESS SPECIFICALLY NOTED ON THESE PLANS.
- ANY MODIFICATIONS OF OR CHANGES TO APPROVED GRADING PLANS MUST BE APPROVED BY THE BUILDING OFFICIAL
- NO GRADING SHALL BE STARTED WITHOUT FIRST NOTIFYING THE BUILDING OFFICIAL. A PRE-GRADING MEETING AT THE SITE IS REQUIRED BEFORE THE START OF THE GRADING WITH THE FOLLOWING PEOPLE PRESENT: OWNER, GRADING CONTRACTOR, DESIGN CIVIL ENGINEER, SOILS ENGINEER, GEOLOGIST, COUNTY GRADING INSPECTOR(S) OR THEIR REPRESENTATIVES, AND WHEN REQUIRED THE ARCHEOLOGIST OR OTHER JURISDICTIONAL AGENCIES. PERMITTE OR HIS AGENT ARE RESPONSIBLE FOR ARRANGING PRE-GRADE MEETING AND MUST NOTIFY THE BUILDING OFFICIAL AT LEAST TWO BUSINESS DAYS PRIOR TO PROPOSED PRE-GRADE MEETING.
- APPROVAL OF THESE PLANS REFLECT SOLELY THE REVIEW OF PLANS IN ACCORDANCE WITH THE LOS ANGELES COUNTY BUILDING CODE AND DOES NOT REFLECT ANY POSITION BY THE COUNTY OF LOS ANGELES OR THE DEPARTMENT OF PUBLIC WORKS REGARDING THE STATUS OF ANY TITLE ISSUES RELATING TO THE LAND ON WHICH THE IMPROVEMENTS MAY BE CONSTRUCTED ANY DISPUTES RELATING TO TITLE ARE SOLELY A PRIVATE MATTER NOT INVOLVING THE COUNTY OF LOS ANGELES OR THE DEPARTMENT OF PUBLIC WORKS.
- ALL GRADING AND CONSTRUCTION ACTIVITIES SHALL COMPLY WITH LOS ANGELES COUNTY CODE. TITLE 12, SECTION 2.12.030 THAT CONTROLS AND RESTRICTS NOISE FROM THE USE OF CONSTRUCTION AND GRADING EQUIPMENT FROM THE HOURS OF 8:00 PM TO 6:30 AM, AND ON SUNDAYS AND HOLIDAYS. (MORE RESTRICTIVE CONSTRUCTION ACTIVITY TIMES MAY GOVERN, AS REQUIRED BY THE DEPARTMENT OF REGIONAL PLANNING AND SHOULD BE SHOWN ON THE GRADING PLANS WHEN APPLICABLE.)
- CALIFORNIA PUBLIC RESOURCES CODE (SECTION 5097.98) AND HEALTH AND SAFETY CODE (SECTION 7050.5) ADDRESS THE DISCOVERY AND DISPOSITION OF HUMAN REMAINS. IN THE EVENT OF DISCOVERY OR RECOGNITION OF ANY HUMAN REMAINS IN ANY LOCATION OTHER THAN A DEDICATED CEMETERY. THE LAW REQUIRES THAT GRADING IMMEDIATELY STOPS AND NO FURTHER EXCAVATION OR DISTURBANCE OF THE SITE, OR ANY NEARBY AREA WHERE HUMAN REMAINS MAY BE LOCATED, OCCUR UNTIL THE FOLLOWING HAS BEEN MEASURES HAVE BEEN

a. THE COUNTY CORONER HAS BEEN INFORMED AND HAS DETERMINED THAT NO INVESTIGATION OF THE CAUSE OF DEATH IS REQUIRED. AND

b. IF THE REMAINS ARE OF NATIVE AMERICAN ORIGIN. THE DESCENDANTS FROM THE DECEASED NATIVE AMERICANS HAVE MADE A RECOMMENDATION FOR THE MEANS OF TREATING OR DISPOSING. WITH APPROPRIATE DIGNITY. OF THE HUMAN REMAINS AND ANY ASSOCIATED GRAVE GOODS.

- THE LOCATION AND PROTECTION OF ALL UTILITIES IS THE RESPONSIBILITY OF THE PERMITTEE.
- ALL EXPORT OF MATERIAL FROM THE SITE MUST GO TO A PERMITTED SITE APPROVED BY THE BUILDING OFFICIAL OR A LEGAL DUMPSITE. RECEIPTS FOR ACCEPTANCE OF EXCESS MATERIAL BY A DUMPSITE ARE REQUIRED AND MUST BE PROVIDED TO THE BUILDING OFFICIAL UPON REQUEST.
- A COPY OF THE GRADING PERMIT AND APPROVED GRADING PLANS MUST BE IN THE POSSESSION OF A RESPONSIBLE PERSON AND AVAILABLE AT THE SITE AT ALL TIMES
- 10. SITE BOUNDARIES, EASEMENTS, DRAINAGE DEVICES, RESTRICTED USE AREAS SHALL BE LOCATED PER CONSTRUCTION STAKING BY FIELD ENGINEER OR LICENSED SURVEYOR. PRIOR TO GRADING, AS REQUESTED BY THE BUILDING OFFICIAL, ALL PROPERTY LINES, EASEMENTS, AND RESTRICTED USE AREAS SHALL BE STAKED.
- 11. NO GRADING OR CONSTRUCTION SHALL OCCUR WITHIN THE PROTECTED ZONE OF ANY OAK TREE AS REQUIRED PER TITLE CHAPTER 22.56 OF THE LOS ANGELES COUNTY ZONING CODE. THE PROTECTED ZONE SHALL MEAN THAT AREA WITHIN THE DRIP LINE OF AN OAK TREE EXTENDING THERE FROM A POINT AT LEAST FIVE FEET OUTSIDE THE DRIP LINE, OR 15 FEET FROM THE TRUNK(S) OF A TREE. WHICHEVER IS GREATER.
- 12. THE STANDARD RETAINING WALL DETAILS SHOWN ON THE GRADING PLANS ARE FOR REFERENCE ONLY. STANDARD RETAINING WALLS ARE NOT CHECKED, PERMITTED, OR INSPECTED PER THE GRADING PERMIT. A SEPARATE RETAINING WALL PERMIT IS REQUIRED FOR ALL STANDARD RETAINING WALLS.

NOTE: THIS NOTE ONLY APPLIES TO STANDARD RETAINING WALLS. GEOGRID FABRIC AND SEGMENTAL RETAINING WALLS DO NOT REQUIRE A SEPARATE RETAINING WALL PERMIT. DETAILS AND CONSTRUCTION NOTES FOR ALL GEOGRID WALLS MUST BE ON THE GRADING PLAN.

- 13. A PREVENTIVE PROGRAM TO PROTECT THE SLOPES FROM POTENTIAL DAMAGE FROM BURROWING RODENTS IS REQUIRED PER SECTION 3307.6 OF THE LOS ANGELES COUNTY BUILDING CODE. OWNER IS TO INSPECT SLOPES PERIODICALLY FOR EVIDENCE OF BURROWING RODENTS AND A FIRST EVIDENCE OF THEIR EXISTENCE SHALL EMPLOY AN EXTERMINATOR FOR THEIR REMOVAL.
- 14. IF GRADING AUTHORIZED BY THIS PLAN IS TO EXTEND THROUGH THE RAINY SEASON, NOVEMBER THROUGH APRIL 15 OF THE FOLLOWING YEAR, SEPARATE UPDATED PLANS FOR EROSION CONTROL MUST BE SUBMITTED PRIOR TO OCTOBER PER SECTION 3319.3 OF THE LOS ANGELES COUNTY BUILDING CODE.
- 15. TRANSFER OF RESPONSIBILITY: IF THE CIVIL ENGINEER, THE SOILS ENGINEER, OR THE ENGINEERING GEOLOGIST OF RECORD IS CHANGED DURING GRADING, THE WORK SHALL BE STOPPED UNTIL THE REPLACEMENT HAS AGREED IN WRITING TO ACCEPT THEIR RESPONSIBILITY WITHIN THE AREA OF TECHNICAL COMPETENCE FOR APPROVAL UPON COMPLETION OF THE WORK. IT SHALL BE THE DUTY OF THE PERMITTEE TO NOTIFY THE BUILDING OFFICIAL IN WRITING OF SUCH CHANGE PRIOR TO THE RECOMMENCEMENT OF SUCH GRADING.

INSPECTION NOTES:

16. THE PERMITTEE OR HIS AGENT SHALL NOTIFY THE BUILDING OFFICIAL AT LEAST ONE WORKING DAY IN ADVANCE OF REQUIRED INSPECTIONS AT FOLLOWING STAGES OF THE WORK. (SECTION 3317 OF THE BUILDING CODE.)

(a) INITIAL. WHEN THE SITE HAS BEEN CLEARED OF VEGETATION AND UNAPPROVED FILL HAS BEEN SCARIFIED, BENCHED OR OTHERWISE PREPARED FOR FILL. FILL SHALL NOT BE PLACED PRIOR TO THIS INSPECTION. NOTE: PRIOR TO ANY CONSTRUCTION ACTIVITIES, INCLUDING GRADING. ALL STORM WATER POLLUTION PREVENTION MEASURES INCLUDING EROSION CONTROL DEVICES WHICH CONTAIN SEDIMENTS MUST BE INSTALLED.

(b) ROUGH. WHEN APPROXIMATE FINAL ELEVATIONS HAVE BEEN ESTABLISHED: DRAINAGE TERRACES, SWALES AND BERMS INSTALLED AT THE TOP OF THE SLOPE; AND THE STATEMENTS REQUIRED IN THIS SECTION HAVE BEEN RECEIVED.

(c) FINAL. WHEN GRADING HAS BEEN COMPLETED; ALL DRAINAGE DEVICES INSTALLED; SLOPE PLANTING ESTABLISHED, IRRIGATION SYSTEMS INSTALLED AND THE AS-BUILT PLANS, REQUIRED STATEMENTS, AND REPORTS HAVE BEEN SUBMITTED AND APPROVED.

- 17. IN ADDITION TO THE INSPECTION REQUIRED OF THE BUILDING OFFICIAL FOR REGULAR GRADING, REPORTS AND STATEMENTS SHALL BE SUBMITTED TO THE BUILDING OFFICIAL IN ACCORDANCE WITH SECTIONS 3317 AND 3318 OF THE LOS ANGELES COUNTY BUILDING CODE.
- 18. ALL GRADED SITES MUST HAVE DRAINAGE SWALES, BERMS, AND OTHER DRAINAGE DEVICES INSTALLED PRIOR TO ROUGH GRADING APPROVAL PER SECTION 3317.6 OF THE LOS ANGELES COUTY BUILDING CODE.
- 19. THE GRADING CONTRACTOR SHALL SUBMIT THE STATEMENT TO THE GRADING INSPECTOR AS REQUIRED BY SECTION 3318.1 OF THE LOS ANGELES COUNTY BUILDING CODE AT THE COMPLETION OF ROUGH GRADING.
- 20. FINAL GRADING MUST BE APPROVED BEFORE OCCUPANCY OF BUILDINGS WILL BE ALLOWED PER SECTION 3318 OF THE LOS ANGELES COUNTY BUILDING CODE

DRAINAGE NOTES:

- 21. ROOF DRAINAGE MUST BE DIVERTED FROM GRADED SLOPES.
- 22. PROVISIONS SHALL BE MADE FOR CONTRIBUTORY DRAINAGE AT ALL TIMES
- 23. ALL CONSTRUCTION AND GRADING WITHIN A STORM DRAIN EASEMENT ARE TO BE DONE PER PRIVATE DRAIN PD NO. OR MISCELLANEOUS TRANSFER DRAIN MTD NO.
- 24. ALL STORM DRAIN WORK IS TO BE DONE UNDER CONTINUOUS INSPECTION BY THE FIELD ENGINEER. WEEKLY STATUS REPORTS SHALL BE SUBMITTED BY THE FIELD ENGINEER TO THE LOCAL BUILDING AND SAFETY DISTRICT OFFICE.

STORMWATER POLLUTION PLAN NOTES

- EVERY EFFORT SHOULD BE MADE TO ELIMINATE THE DISCHARGE OF NON-STORMWATER FROM THE PROJECT SITE AT ALL TIMES.
- ERODED SEDIMENTS AND OTHER POLLUTANTS MUST BE RETAINED ON-SITE AND MAY NOT BE TRANSPORTED FROM THE SITE VIA SHEET FLOW, SWALES, AREA DRAINS, NATURAL DRAINAGE COURSES OR WIND.
- STOCKPILES OF EARTH AND OTHER CONSTRUCTION RELATED MATERIALS MUST BE PROTECTED FROM BEING TRANSPORTED FROM THE SITE BY THE FORCES OF WIND OR WATER.
- FUELS, OILS, SOLVENTS, AND OTHER TOXIC MATERIALS MUST BE STORED IN ACCORDANCE WITH THEIR LISTING AND ARE NOT TO CONTAMINATE THE SOIL AND SURFACE WATERS. ALL APPROVED STORAGE CONTAINERS ARE TO BE PROTECTED FROM THE WEATHER. SPILLS MUST BE CLEANED UP IMMEDIATELY AND DISPOSED OF IN A PROPER MANNER. SPILLS MAY NOT BE WASHED INTO THE DRAINAGE SYSTEM.
- EXCESS OR WASTE CONCRETE MAY NOT BE WASHED INTO THE PUBLIC WAY OR ANY OTHER DRAINAGE SYSTEM. PROVISIONS SHALL BE MADE TO RETAIN CONCRETE WASTES ON-SITE UNTIL THEY CAN BE DISPOSED OF AS SOLID WASTE
- TRASH AND CONSTRUCTION RELATED SOLID WASTES MUST BE DEPOSITED INTO A COVERED RECEPTACLE TO PREVENT CONTAMINATION OF RAINWATER AND DISPERSAL BY WIND.
- SEDIMENTS AND OTHER MATERIALS MAY NOT BE TRACKED FROM THE SITE BY VEHICLE TRAFFIC. THE CONSTRUCTION ENTRANCE ROADWAYS MUST BE STABILIZED SO AS TO INHIBIT SEDIMENTS FROM BEING DEPOSITED INTO THE PUBLIC WAY. ACCIDENTAL DEPOSITIONS MUST BE SWEPT UP IMMEDIATELY AND MAY NOT BE WASHED DOWN BY RAIN OR OTHER MEANS.
- SLOPES WITH DISTURBED SOILS OR DENUDED OF VEGETATION MUST BE STABILIZED SO AS TO INHIBIT EROSION BY WIND AND WATER.
- AS THE PROJECT OWNER OR AUTHORIZED AGENT OF THE OWNER. I HAVE READ AND UNDERSTAND THE REQUIREMENTS LISTED ABOVE, NECESSARY TO CONTROL STORM WATER POLLUTION FROM SEDIMENTS, EROSION, AND CONSTRUCTION MATERIALS, AND I CERTIFY THAT I WILL COMPLY WITH THESE REQUIREMENTS.

PRINT NAME (OWNER OR AUTHORIZED AGENT OF THE OWNER) SIGNATURE _ (OWNER OR AUTHORIZED AGENT OF THE OWNER)

THE FOLLOWING BMPs AS OUTLINED IN, BUT NOT LIMITED TO, THE BEST MANAGEMENT PRACTICE HANDBOOK, CALIFORNIA STORMWATER QUALITY TASK FORCE, SACRAMENTO, CALIFORNIA 1993, OR THE LATEST REVISED EDITION. MAY APPLY DURING THE CONSTRUCTION OF THIS PROJECT (ADDITIONAL MEASURES MAY BE REQUIRED IF DEEMED APPROPRIATE BY COUNTY INSPECTORS)

CA001-DEWATERING OPERATIONS CA002-PAVING OPERATIONS CA003-STRUCTURE CONSTRUCTION AND PAINTING CAO10-MATERIAL DELIVERY AND STORAGE CAO11-MATERIAL USE CA012-SPILL PREVENTION AND CONTROL CA020-SOLID WASTE MANAGEMENT CAO21-HAZARDOUS WASTE MANAGEMENT CA022-CONTAMINATED SOIL MANAGEMENT CA023-CONCRETE WASTE MANAGEMENT CA030-VEHICLE AND EQUIPMENT CLEANING CAO31-VEHICLE AND EQUIPMENT FUELING CA032-VEHICLE AND EQUIPMENT MAINTENANCE CA040-EMPLOYEE/SUBCONTRACTOR TRAINING ESC01-SCHEDULING ESC02-PRESERVATION OF EXISTING VEGETATION ESC10-SEEDING AND PLANTING

ESC11-MULCHING

GSS INC.

ESC20-GEOTEXTILES AND MATS ESC21-DUST CONTROLS ESC22-TEMPORARY STREAM CROSSING ESC23-CONSTRUCTION ROAD STABILIZATION ESC24-STABILIZED CONSTRUCTION ENTRANCE ESC30-EARTH DIKE ESC31-TEMPORARY DRAINS AND SWALES ESC32-SLOPE DRAIN ESC40-OUTLET PROTECTION ESC41-CHECK DAMS ESC42-SLOPE ROUGHENING/TERRACING ESC50-SILT FENCE ESC51-STRAW BALE BARRIERS ESC52-SAND BAG BARRIERS ESC53-BRUSH OR ROCK FILTER ESC54-STORM DRAIN INLET PROTECTION ESC55-SEDIMENT TRAP ESC56-SEDIMENT BASIN

LEGEND

C.B. _ _ _ _ CATCH BASIN C.F. _ _ _ _ CURB FACE CONC._ _ _ _ CONCRETE DWY. _ _ _ _ DRIVEWAY F.F. _ _ _ _ FINISHED FLOOR F.G. _ _ _ _ FINISHED GRADE F.H. _ _ _ _ FIRE HYDRANT F.L. _ _ _ FLOW LINE F.S. _ _ _ _ FINISHED SURFACE G.B. _ _ _ _ GRADE BREAK H.P. _ _ _ _ HIGH POINT MAX. _ _ _ _ MAXIMUM MIN. _ _ _ _ MINIMUM P.L. _ _ _ PROPERTY LINE PVMT. _ _ _ PAVEMENT R. _ _ _ _ RADIUS T.C. _ _ _ TOP OF CURB T.C.B. _ _ _ _ TOP OF CATCH BASIN T.W. _ _ _ TOP OF WALL INV. _ _ _ _ INVERT CL. _ _ _ _ CENTER LINE

PROPOSED CONTOUR (634) EXISTING ELEVATION 634 PROPOSED ELEVATION → → FENCE - FIRE HYDRANT → FLOW LINE — SLOPE trining CONCRETE PROPOSED WALL EXISTING WALL ____ RIDGE LINE

---- GRADE BREAK LINE

-- EXISTING CONTOUR

LEGAL DESCRIPTION


LOT 7 OF TRACT NO. 8018 AS PER MAP RECORDED IN BOOK 165 PAGES 30-31 OF MAPS IN THE OFFICE OF THE COUNTY RECORDER OF SAID COUNTY, AND THE WESTERLY 10 FEET OF THAT PORTION OF THE VACATED ALLEY ADJOINING SAID LOT ON THE EASTERLY LINE.

ALSO THAT TRACT NO. 8018 AS PER MAP RECORDED IN BOOK 165 PAGES 30-31 OF MAPS IN THE OFFICE OF THE COUNTY, LIVING WESTERLY OF THE SOUTHERLY PROLONGATION OF THE EASTERLY LINE OF SAID LOT.

PARCEL 2:

LOT 8 OF TRACT 8018 AS PER MAP RECORDED IN BOOK 165 PAGES 30-31 OF MAPS IN THE OFFICE OF THE COUNTY RECORDER OF SAID COUNTY.

ALSO THAT PORTION OF THE SOUTH HALF OF AN ALLEY AS SHOWN ON SAID TRACT, VACATED BY RESOLUTION NO 142 RECORDED AS INSTRUMENT NO. 29088 ON OCT. 21, 1968 OFFICIAL RECORDS OF SAID COUNTY, LYING WESTERLY OF THE NORTHERLY PROLONGATION OF THE EASTERLY LINE OF SAID LOT.

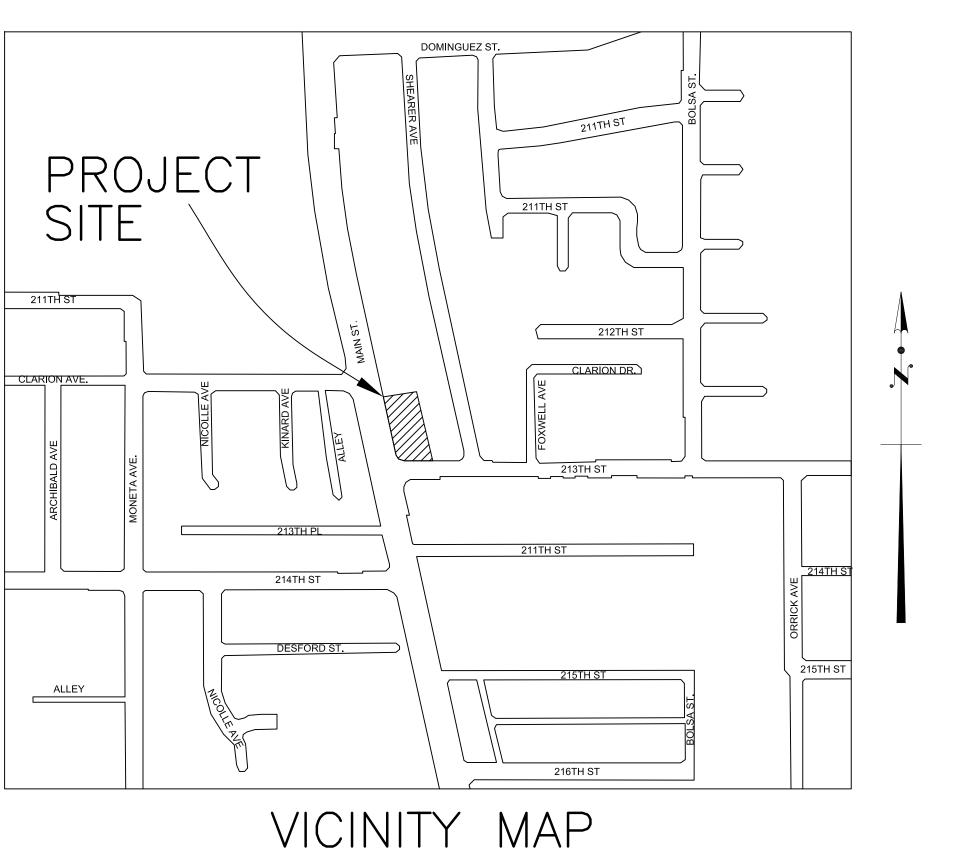

NOT TO SCALE

CONSTRUCTION NOTES

- (1) INSTALL 12"X12" GRATE DRAIN(ALHABRA FDRY. STD. 2011)
- (2) 4" DIA. PVC PIPE(SCHEDULE 40)
- (3) 6" CONC. ON COMPACTED PAVEMENT
- (4) 6' HIGH CONC BLOCK WALL PER APPROVED ARCHITECTURAL PLANS.
- (5) LANDSCAPE AREA PER APPROVED LANDSCAPE PLANS.
- (6) CONST. 4" DIA CAST IRON PRESSURED PIPE
- (7) DUAL PUMPING SYSTEM PER SEPARATE PERMIT
- (8) CONST. CONC DRIVEWAY PER APWA STD PLAN


ADDITIONAL NOTES

- THIS GRADING PLAN WAS PREPARED FOR THE EXCLUSIVE USE OF JEFF DAUN. IT SHALL NOT BE TRANSFERRED TO OR USED BY A THIRD PARTY WITHOUT THE PRIOR WRITTEN CONSENT OF THIS OFFICE.
- II. THE GEOTECHNICAL REPORT PREPARED BY NORCAL ENGINEERING. DATED JANUARY 25, 2005 (PROJECT NO. 11869-05) IS PART OF THIS GRADING PLAN AND THE CONTRACTOR SHALL COMPLY WITH ALL ITS RECOMMENDATIONS AND REQUIREMENTS.
- III. ALL DRAINAGE PIPES TO BE PVC SCHEDULE 40 MINIMUM OR EQUIVALENT WITH 4" MINIMUM DIAMETER
- IV. RETAINING WALLS REQUIRES SEPARATE PERMIT.
- V. CURB DRIAN REQUIRES SEPARATE PERMIT FROM ENGINEERING DEPT.
- VI. THE CONTRACTOR SHALL COMPLY WITH CITY OF CARSON ORDINANCE RELATED TO STANDARD URBAN STORMWATER MITIGATION PLAN (STATE OF CALIFORNIA MANDATED) AND COMPLY WITH NPDES PERMIT REQUIREMENTS.
- VII. THE SOILS ENGINEER OF RECORDS SHALL INSPECT AND APPROVE THE FOUNDATION EXCAVATIONS BEFORE STEEL OR CONCRETE IS PLACED.
- VIII. FOR DETAIL OF THE FOOTING AND FOUNDATION, REFER TO THE APPROVED STRUCTURAL AND ARCHITECTURAL DRAWINGS.
- IX. VOLUME OF CUT AND FILL 1 500

COI.		1,300	U. I
FILL :		1,500	C.Y
OVER	EX :		

H. STEVE NAZEMI

GPC NO. XXXXXXXXX **CUP XXXXXX**

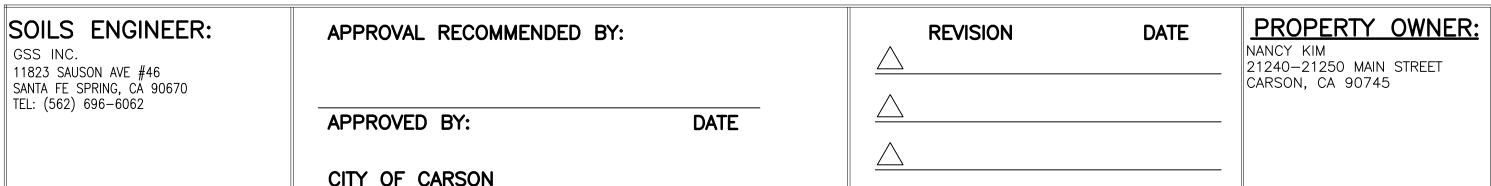



DHS & ASSOCIATES, INC. 275 CENTENNIAL WAY, #205 TUSTIN, CA 92780-3709 (714) 665-6569

<u> 10/08/202</u>1

GRADING AND DRAINAGE PLAN FOR 7 DETACHED TOWNHOUSES SCALE: 1"=10' DRAWN BY: S.N. DATE: 10/08/2021 REVISED: 21240-21250 MAIN STREET CARSON, CA 90745 JOB NO. SHEET

GRAPHIC SCALE

